

- STANDARD NOTES:**
1. THIS PLAN SHALL BE KEPT ON SITE AT ALL TIMES AND UPDATED TO REFLECT ANY CHANGES.
 2. CONCRETE WASTE & WASHOUT WATER FROM MIXING TRUCKS SHALL BE CONTAINED ON SITE, REMOVED FROM THE SITE & PROPERLY DISPOSED. MATERIALS SHOULD NOT ENTER STATE WATERS.
 3. CONTRACTOR IS RESPONSIBLE FOR INSTALLING AND MAINTAINING TEMPORARY EROSION AND SEDIMENT CONTROL DURING CONSTRUCTION & ESTABLISHING ANY REQUIRED PERMANENT BEST MANAGEMENT PRACTICES (BMPs).
 4. CONTRACTOR IS RESPONSIBLE FOR COMPLYING WITH ALL LOCAL, STATE, AND FEDERAL LAWS & OBTAINING ALL REQUIRED PERMITS.
 5. CLEARING OR GRADING SHALL NOT BEGIN UNTIL ALL SEDIMENT CONTROL DEVICES HAVE BEEN INSTALLED.
 6. INLET PROTECTION SHALL BE INSTALLED IN CONJUNCTION WITH STORM DRAIN INLETS WHERE DRAINAGE AREA IS NOT VEGETATED.
 7. BMPs SHALL BE USED, MODIFIED & MAINTAINED WHENEVER NECESSARY TO REFLECT CURRENT CONDITIONS. BMPs SHALL BE INSPECTED WEEKLY & AFTER EVERY PRECIPITATION EVENT. ACCUMULATED SEDIMENT SHALL BE REMOVED FROM BMPs WHEN THE SEDIMENT LEVEL REACHES 1/2 THE HEIGHT OF THE BMP.
 8. EMERGENCY ACCESS MUST BE KEPT OBSTACLE FREE & PASSABLE AT ALL TIMES.
 9. SIDEWALKS ADJACENT TO CONSTRUCTION SITES SHALL BE MAINTAINED FOR PUBLIC USE BY THE CONTRACTOR. IN AREAS WHERE CONSTRUCTION IS TAKING PLACE NEXT TO THE SIDEWALK AND OVERHEAD HAZARDS ARE POSSIBLE, CONTRACTOR IS RESPONSIBLE FOR INSTALLING AND MAINTAINING SIDEWALK PROTECTION.
 10. FIELD LOCATE ALL UTILITIES PRIOR TO ANY CONSTRUCTION ACTIVITIES.
 11. SURVEY INFORMATION FROM RECORD PLAT AND MODIFIED FOR USE AS A SITE PLAN.

ZONED:	R-1
SETBACKS:	25' FRONT, 20' REAR, 7' SIDE
LOT AREA:	13,239 SF
BUILDING HEIGHT:	32'-0"
ALLOWABLE BUILDING HEIGHT:	35'-0" MAX

Sheet List	
Sheet Number	Sheet Name

C100	SITE PLAN
SP1	SPECIFICATIONS
SP2	SPECIFICATIONS
A100	MAIN LEVEL FLOOR PLAN
A101	UPPER LEVEL FLOOR PLAN
A102	ROOF PLAN
A103	BUILDING ELEVATIONS
A104	BUILDING ELEVATIONS
A105	BUILDING SECTIONS
A106	BUILDING SECTIONS
S101	FOUNDATION PLAN
S102	MAIN LEVEL FLOOR FRAMING PLAN
S103	UPPER LEVEL AND LOWER ROOF FRAMING PLAN
S104	UPPER ROOF FRAMING PLAN

SHERIDAN
WYOMING
307-752-9146

BRIDGER
ENGINEERING
AND DESIGN

BE

"STRUCTURE ONLY"

SITE PLAN
GLOCK RESIDENCE
30 GENEVA LN
SHERIDAN, WY 82801
OWNER/CONTRACTOR 480.239.6512

Job #	2022-22
File	22.022
Date	2022.10.24
Drawn	KAB
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Rel'd	20-17-2022
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Sheet Number
C100
SHEET 1 OF 14

1 SITE PLAN
C100 SCALE: 1" = 10'-0"

10. ENERGY EFFICIENCY - CONTINUED

RECOMMENDED- RECESSED LUMINARIES INSTALLED IN THE BUILDING THERMAL ENVELOPE SHALL BE SEALED TO LIMIT AIR LEAKAGE BETWEEN CONDITIONED AND UNCONDITIONED SPACES. SHALL BE IFC RATED & LABELED AS MEETING ASTM E 283 AND SEALED W/ A GASKET OR CAULK BETWEEN THE HOUSING AND WALL OR CEILING COVERING.

RECOMMENDED- MECHANICAL SYSTEM PIPING CAPABLE OF CARRYING FLUIDS ABOVE 105°F OR BELOW 55°F SHALL BE INSTALLED TO R-5 MINIMUM

RECOMMENDED- ALL CIRCULATING SERVICE HOT WATER PIPING SHALL BE INSULATED TO R-2 MINIMUM SYSTEMS SHALL INCLUDE AN AUTOMATIC OR READILY ACCESSIBLE MANUAL SWITCH TO TURN OFF THE CIRCULATING PUMP WHEN THE SYSTEM IS NOT IN USE.

RECOMMENDED- SUPPLY AND RETURN DUCTS SHALL BE INSULATED TO A MINIMUM OF R-6. DUCTS IN FLOOR TRUSSES SHALL BE INSULATED TO A MINIMUM OF R-6. EXCEPTION- DUCTS OR PORTIONS THEREOF LOCATED COMPLETELY INSIDE THE BUILDING THERMAL ENVELOPE.

RECOMMENDED- ALL DUCTS, AIR HANDLERS, FILTER BOXES AND BUILDING CAVITIES USED AS DUCTS SHALL BE SEALED, JOINTS AND SEAMS SHALL COMPLY WITH SECTION M1601.3.1 OF THE INTERNATIONAL RESIDENTIAL CODE. MAXIMUM DUCT LEAKAGE SHALL BE 10% FOR DUCTS WITHIN THE BUILDING ENVELOPE AND 5% FOR DUCTS OUTSIDE THE BUILDING THERMAL ENVELOPE.

RECOMMENDED- BUILDING FRAMING CAVITIES SHALL NOT BE USED AS SUPPLY DUCTS.

RECOMMENDED- OUTDOOR AIR INTAKES AND EXHAUSTS SHALL HAVE AN AUTOMATIC OR GRAVITY DAMPER THAT CLOSURES WHEN THE VENTILATION SYSTEM IS NOT OPERATING

RECOMMENDED- HEATING AND COOLING EQUIPMENT SHALL BE SIZED IN ACCORDANCE WITH SECTION M1401.3 OF THE IRC; ACCA MANUAL J OR OTHER APPROVED METHODOLOGY. MECHANICAL CONTRACTOR TO PROVIDE CALCULATIONS WITH DEFERRED SUBMITTAL.

RECOMMENDED- A MINIMUM OF 100% OF THE LAMPS IN PERMANENTLY INSTALLED LIGHTING FIXTURES SHALL BE HIGH EFFICACY LAMPS

RECOMMENDED- PERMANENTLY INSTALLED LIGHTING FIXTURES SHALL BE CONTROLLED EITHER A DIMMER, AND OCCUPANT SENSOR CONTROL OR OTHER CONTROL THAT IS CONTROLLED OR BUILT INTO THE FIXTURE. LIGHTING CONTROLS SHALL NOT BE REQUIRED FOR BATHROOMS, HALLWAYS, EXTERIOR LIGHTING FIXTURES & LIGHTING DESIGNED FOR SAFETY OR SECURITY

RECOMMENDED- PERMANENTLY INSTALLED EXTERIOR LIGHTING WHOS POWER IS GREATER THAN 30 WATTS SHALL BE CONTROLLED BY A MANUAL ON OFF SWITCH WHICH PERMITS AUTOMATIC SHOT-OFF ACTIONS. LIGHTING SHALL BE AUTOMATICALLY SHUT OFF WHEN DAYLIGHT IS PRESENT AND SATISFIES THE LIGHTING NEEDS.

11. MECHANICAL

CONTRACTOR SHALL PROVIDE ALL LABOR, MATERIALS AND EQUIPMENT TO INSTALL VENTILATION, HEATING AND AIR CONDITIONING EQUIPMENT; DUCTING AND ALL RELATED CONTROLS. ALL WORK SHALL COMPLY WITH THE IRC PART V-MECHANICAL, CHAPTERS 12-23, STATE AND LOCAL CODES AND ORDINANCES. ALL EQUIPMENT SHALL BE INSTALLED PER THE MANUFACTURER'S PRINTED INSTRUCTIONS AND LOCAL CODES.

THE MECHANICAL SUBCONTRACTORS SHALL BE RESPONSIBLE FOR THE FINAL DESIGN OF THE SYSTEMS AS WELL AS THE EXECUTION OF THE WORK ACCORDING TO ACCEPTED STANDARDS OF ENGINEERING, WORKMANSHIP AND REGULATORY REQUIREMENTS. MECHANICAL CONTRACTORS TO PROVIDE ADDITIONAL DRAWINGS, SPECIFICATIONS AND ENGINEER'S CERTIFICATION AS REQUIRED BY FEDERAL, STATE OR LOCAL LAWS AND BUILDING DEPARTMENT JURISDICTION.

HEATING AND COOLING EQUIPMENT AND APPLIANCES SHALL BE INSTALLED IN ACCORDANCE WITH MANUFACTURER'S INSTALLATIONS INSTRUCTION AND THE REQUIREMENTS OF IRC CHAPTERS 13 & 14

EXHAUST SYSTEMS SHALL BE INSTALLED PER CHAPTER 15

SOLID FUEL BURNING APPLIANCES SHALL BE PROVIDED WITH COMBUSTION AIR IN ACCORDANCE WITH THE APPLIANCE MANUFACTURER'S INSTALLATION INSTRUCTIONS. THE REQUIREMENTS FOR COMBUSTION AIR FOR GAS FIRED APPLIANCES SHALL BE IN ACCORDANCE WITH CHAPTERS 24.

FUEL BURNING APPLIANCES SHALL BE VENTED TO THE OUTDOORS IN ACCORDANCE WITH THEIR LISTING AND LABEL AND MANUFACTURER'S INSTALLATION INSTRUCTIONS PER IRC CHAPTER 18.

FREE STANDING OR BUILT-IN RANGES SHALL HAVE A VERTICAL CLEARANCE ABOVE THE COOKING TOP OF NOT LESS THAN 30 INCHES.

BOILERS SHALL BE INSTALLED IN ACCORDANCE WITH IRC CHAPTER 20. WATER HEATERS SHALL BE INSTALLED IN ACCORDANCE WITH IRC CHAPTER 20. HYDRONIC PIPING SYSTEMS SHALL BE INSTALLED PER IRC CHAPTER 21. SOLAR ENERGY SYSTEMS SHALL BE DESIGNED, CONSTRUCTED AND INSTALLED PER IRC CHAPTER 23. GAS FIRED APPLIANCES SHALL BE VENTED IN ACCORDANCE WITH IRC CHAPTER 24.

THE HOUSE AS PROPOSED WILL UTILIZE A FORCED AIR COOLING SYSTEM. FORCED AIR UNIT (FAU) MINIMUM EFFICIENCY SHALL BE 90% AFUE. ALL SUPPLY AND RETURN DUCTING SHALL BE SEALED WITH MASTIC AT JOISTS AND BE SUBSTANTIALLY AIR TIGHT. (250 CFM @ 0.5 PASCAL MAXIMUM). FAU SHALL BE ISOLATED FROM DUCTING WITH RUBBER JOINTS OR BOOTS. LATERALS SHALL BE SIZED TO PREVENT EXCESSIVE DELIVERY DUCT VELOCITY (5 FEET/3 SECOND MAXIMUM).

THIS HOUSE AS PROPOSED WILL UTILIZE A RADIANT FLOOR HYDRONIC SYSTEM WITH A BOILER AND SIDE ARM WATER STORAGE TANK

HYDRONIC TUBING WILL BE ATTACHED TO REINFORCEMENT AT ALL SLAB ON GRADE LOCATIONS OR ATTED TO UNDERSIDE OF FLOOR SHEATHING. TUBING SHALL BE CROSSED LINKED POLYETHYLENE WITH OXYGEN INHIBITOR SUCH AS BEX OR WISBRO.

RADIANT FLOOR HEATING SYSTEMS SHALL HAVE A THERMAL BARRIER IN ACCORDANCE WITH SECTIONS M1203.2.1-4

SLAB ON GRADE APPLICATIONS SHALL HAVE A MINIMUM OF R-5 INSULATION BELOW THE PIPING AND ASPHALT EXPANSION JOINT MATERIAL OR SIMILAR INSULATING MATERIAL WHERE THE HEATED SLAB MEETS A FOUNDATION WALL OR OTHER CONDUCTIVE SLAB.

SUSPENDED FLOOR APPLICATIONS SHALL HAVE A MINIMUM OF R-11 INSULATION BELOW THE PIPING.

PROVIDE PREFABRICATED FIREPLACE, NATURAL GAS FUELED AND DIRECT VENTED THRU THE WALL AT THE LOCATION NOTED ON THE PLANS. APPLIANCE TO BE INSTALLED PER MANUFACTURER'S INSTRUCTIONS AND LOCAL CODES.

EVERY CHIMNEY OR FLUE SHALL BE EQUIPPED WITH AN APPROVED SPARK ARRESTER.

FUEL FIRED WATER HEATERS SHALL NOT BE INSTALLED IN ROOMS USED AS A STORAGE CLOSET. WATER HEATERS INSTALLED IN A BEDROOM OR BATHROOM SHALL BE INSTALLED IN A SEALED ENCLOSURE TO THAT COMBUSTION AIR WILL NOT BE TAKEN FROM THE LIVING SPACE. DIRECT VENT WATER HEATERS ARE NOT REQUIRED TO BE INSTALLED WITHIN AN ENCLOSURE.

A LUMINAIRE CONTROLLED BY A SWITCH LOCATED AT THE PASSAGEWAY OPENING AND A RECEPTACLE OUTLET SHALL BE INSTALLED AT OR NEAR THE APPLIANCE.

12. PLUMBING

CONTRACTOR SHALL PROVIDE ALL LABOR AND MATERIALS TO INSTALL ALL PERIMETER STORM DRAINAGE, FLOOR DRAINS, PLUMBING, RATED FIXTURES, GAS PIPING AND RADON GAVE VENT PIPING. ALL WORK SHALL COMPLY WITH IRC PART VI - FUEL GAS, CHAPTER 24 AND PART VII - PLUMBING, CHAPTERS 25 THRU 33, STATE AND LOCAL CODES AND ORDINANCES.

WATER HEATERS SHALL BE LOCATED PER IRC CHAPTER 20 AND SHALL BE INSTALLED IN ACCORDANCE WITH IRC CHAPTERS 25 & 28

WATER SUPPLY AND DISTRIBUTION SHALL COMPLY WITH IRC CHAPTER 29.

SANITARY DRAINAGE SHALL COMPLY WITH IRC CHAPTER 20

VENTING SHALL COMPLY WITH IRC CHAPTER 21. FLOOR TRAPS SHALL COMPLY WITH IRC CHAPTER 22.

THE MAXIMUM WATER CONSUMPTION FLOW RATES AND QUANTITIES FOR ALL PLUMBING FIXTURES AND FITTURE FITTINGS SHALL BE IN ACCORDANCE WITH TABLE P2903.3 HIGH EFFICIENCY TOILETS, WHEN SPECIFIED, SHALL BE DUAL FLUSH OR <1.3 GPF.

NO WATER CLOSET SHALL BE SET CLOSER THAN 15" FROM ITS CENTER TO ANY SIDE WALL OR OBSTRUCTION. THE CLEAR SPACE IN FRONT OF THE CLOSET SHALL NOT BE LESS THAN 21". PROVIDE ELONGATED BOWLS UON.

SHOWER COMPARTMENTS SHALL HAVE AT LEAST 900 SQUARE INCHES OF INTERIOR CROSS SECTIONAL AREA AND SHALL NOT BE LESS THAN 30" IN MINIMUM DIMENSION. SHOWER FLOORS AND WALLS ABOVE BATHTUBS WITH INSTALLED SHOWER HEADS AND SHOWER COMPARTMENTS SHALL BE FINISHED WITH A NON-ABSORBENT SURFACE EXTENDING TO A HEIGHT OF 6'-0" MINIMUM ABOVE THE FLOOR.

PROVIDE CAST-IN-PLACE CAST IRON FLOOR DRAINS WITH INTEGRAL SAND TRAP, PIPED & 1% MINIMUM SLOPE TO DAYLIGHT IN THE GARAGE. DAYLIGHTED END SHALL BE SCREENED AND PROTECTED WITH ROCK RIPRAP. IF EXPANSIVE SOILS ARE PRESENT, DO NOT CONNECT FLOOR DRAIN OUTFALL TO FOUNDATION PERIMETER DRAIN UNTIL 10 FEET AWAY FROM THE FOUNDATION.

PROVIDE FLOOR DRAIN PIPED TO HOUSE SEWER IN ALL LAUNDRY ROOM UNLESS WASHING MACHINE IS PLACED IN A WATER TIGHT PAN COMPLYING WITH IRC SECTION P2801.5.

WHERE WATER HEATERS OR HOT WATER STORAGE TANKS ARE INSTALLED IN LOCATIONS WHERE LEAKAGE WOULD CAUSE DAMAGE TO THE FLOOR OR WATER HEATERS SHALL BE INSTALLED IN A GALVANIZED STEEL PAN PER IRC P2801.5. LISTED PANS SHALL COMPLY WITH CSA L.C.S. THE PAN SHALL BE DRAINED BY AND INDIRECT WASTE PIPE PER IRC P2801.5.1 AND TERMINATED OVER A SUITABLY LOCATED INDIRECT WASTE RECEIVER OR EXTENDED TO THE BUILDING EXTERIOR AND TERMINATED BETWEEN 6" AND 24" ABOVE THE ADJACENT GROUND SURFACE PER IRC P2801.5.2

PROVIDE (2) FROST PROOF HOSE BIBBS AT LOCATIONS NOTED ON THE PLANS

APPLIANCES AND EQUIPMENT USED FOR HEATING WATER OR STORING HOT WATER SHALL BE PROTECTED BY A PWR AND TRV OR COMBINATION P/TRV PER IRC SECTION P2803 AND SHALL NOT BE DIRECTLY CONNECTED TO THE DRAINING SYSTEM. THE DISCHARGE SHALL BE THROUGH AN AIR GAP TO AN INDIRECT WASTE RECEIVER OR OTHER APPROVED MEANS.

13. ELECTRICAL

CONTRACTOR SHALL PROVIDE ALL LABOR, MATERIALS AND EQUIPMENT TO INSTALL ALL WIRING AND RELATED FIXTURES. ALL WORK SHALL COMPLY WITH IRC PART VIII - ELECTRICAL, CHAPTERS 33 THRU 41, THE 2017 NEC, STATE AND LOCAL CODES AND ORDINANCES.

THE ELECTRICAL SUBCONTRACTORS SHALL BE RESPONSIBLE FOR THE FINAL DESIGN OF THE SYSTEMS AS WELL AS THE EXECUTION OF THE WORK ACCORDING TO ACCEPTED STANDARDS OF ENGINEERING, WORKMANSHIP AND REGULATORY REQUIREMENTS. ELECTRICAL CONTRACTORS TO PROVIDE ADDITIONAL DRAWINGS, SPECIFICATIONS AND ENGINEERS CERTIFICATION AS REQUIRED BY FEDERAL, STATE OR LOCAL LAWS AND BUILDING DEPARTMENT JURISDICTION.

MOUNT METER SOCKET AT 5'-6" ABOVE FINISHED GRADE.

PROVIDE CONCRETE ENCASED ELECTRODE (UFER GROUND) PER IRC SECTION E3608.1.2

PROVIDE 200 AMP 4P CIRCUIT SERVICE PANEL (OVER CURRENT DEVICE) WITH DISCONNECT, AT THE LOCATION NOTED ON PLANS. SERVICE PANELS SHALL NOT BE LOCATED IN THE VICINITY OF EASILY IGNITABLE MATERIALS, SUCH AS CLOTHES, CLOSET OR IN BATHROOMS. SERVICE CONDUCTORS AND EQUIPMENT TO BE SIZED PER IRC CHAPTER 26.

A MINIMUM OF (2) 20 AMP BRANCH CIRCUITS SHALL BE PROVIDED TO SERVE RECEPTACLES LOCATED IN THE KITCHEN, PANTRY, BREAK DING AREAS. THE KITCHEN COUNTER TOP RECEPTACLES SHALL BE SERVED BY NOT LESS THAN (2) 20 AMP SMALL APPLIANCE BRANCH CIRCUITS.

A MINIMUM OF (1) 20 AMP BRANCH CIRCUIT SHALL BE PROVIDED TO SERVE RECEPTACLES LOCATED IN THE LAUNDRY AREA AND SHALL SERVE ONLY RECEPTACLES LOCATED IN THE LAUNDRY AREA.

A MINIMUM OF (2) 20 AMP BRANCH CIRCUITS AND (1) 30 AMP BRANCH CIRCUIT SHALL BE PROVIDED TO SERVE THE RV GARAGE.

A MINIMUM OF (1) 20 AMP BRANCH CIRCUIT SHALL BE PROVIDED TO SERVE RECEPTACLES LOCATED IN THE BATHROOM AND SHALL SERVE ONLY RECEPTACLES LOCATED IN THE BATHROOM.

RECEPTACLES ABOVE COUNTERS IN KITCHEN SHALL BE SPACED NOT MORE THAN 4 FEET ON AND WITHIN 2 FEET OF EACH END, INCLUDING ISLANDS AND PENINSULAR. PROVIDE A MINIMUM OF (1) RECEPTACLE PER COUNTER SPACE OF 12" OR GREATER.

PROVIDE AT LEAST (1) RECEPTACLE OUTLET IN WEATHER PROOF HOUSING, ACCESSIBLE AT GRADE LEVEL AND NOT MORE THAN 6'-6" ABOVE GRADE AT THE FRONT AND AT THE BACK OF EACH DWELLING.

ALL 125 VOLT, SINGLE PHASE RECEPTACLES INSTALLED IN BATHROOMS, GARAGES, OUTDOORS, CRAWLSPACES, UNFINISHED BASEMENTS, KITCHEN COUNTERTOP SURFACES AND WITHIN 6 FEET OF LAUNDRY, UTILITY OR BAR SINKS, (EXCEPT DEDICATED USE) SHALL BE GROUND FAULT CIRCUIT INTERRUPTER PROTECTED FOR PERSONNEL. RECEPTACLES IN GARAGES TO BE MOUNTED 42" MINIMUM ABOVE FINISHED FLOOR.

ALL BRANCH CIRCUITS INSTALLED IN FAMILY, DINING, LIVING ROOMS, PARLORS, LIBRARIES, DEN'S, BEDROOMS, SUNROOMS, RECREATION ROOMS, CLOSETS, HALLWAYS AND SIMILAR ROOMS OR AREAS SHALL BE PROTECTED BY A COMBINATION TYPE ARC-FAULT CIRCUIT INTERRUPTER. KITCHENS, BATHS AND GARAGES ARE EXEMPT FROM THIS REQUIREMENT.

LUMINARIES INSTALLED IN CLOTHES CLOSETS SHALL BE LIMITED TO SURFACE MOUNTED OR RECESSED INCANDESCENT LUMINARIES WITH COMPLETELY ENCLOSED LAMPS, SURFACE MOUNTED OR RECESSED FLOURESCENT LUMINARIES AND SURFACE MOUNTED FLOURESCENT OR LED LUMINARIES IDENTIFIED AS SUITABLE FOR INSTALLATION WITHIN THE STORAGE AREA. SURFACE MOUNTED INCANDESCENT OR LED LUMINARIES SHALL BE MOUNTED ON THE WALL ABOVE THE DOOR OR ON THE CEILING PROVIDED THERE IS A MINIMUM CLEARANCE OF 12 INCHES BETWEEN THE FIXTURE AND THE NEAREST POINT OF A STORAGE AREA. INCANDESCENT FIXTURES WITH OPEN OR PARTIALLY ENCLOSED LAMPS, PENDANT FIXTURES AND LAMP HOLDERS ARE NOT PERMITTED.

PROVIDE (1) 20 AMP CIRCUIT FOR FUTURE USE IN THE ATTIC AND IN THE CRAWL SPACE. TERMINATE THE CIRCUIT WITH A KEYLESS PORCELAIN FIXTURE.

PROVIDE DEDICATED 15 AMP CIRCUIT FOR REFRIGERATORS AND FREEZERS.

SMOKE ALARMS SHALL BE INSTALLED IN THE FOLLOWING LOCATIONS:
1. IN EACH SLEEPING ROOM.
2. OUTSIDE EACH SEPARATE SLEEPING AREA IN THE IMMEDIATE VICINITY OF THE BEDROOMS.
3. ON EACH ADDITIONAL STORY OF THE DWELLING, INCLUDING BASEMENTS BUT NOT INCLUDING CRAWLSPACES AND UNINHABITABLE ATTICS.

WHEN MORE THAN ONE SMOKE ALARM IS REQUIRED THE DEVICE SHALL BE INTERCONNECTED IN SUCH A MANNER THAT ACTIVATION OF ONE ALARM WILL ACTIVATE ALL OF THE ALARMS IN THE INDIVIDUAL UNIT. ALARMS SHALL BE HARDWIRED WITH BATTERY BACKUP.

ALL SMOKE ALARMS SHALL BE LISTED AND INSTALLED IN ACCORDANCE WITH THE PROVISIONS OF THIS CODE AND THE HOUSEHOLD FIRE WARNING EQUIPMENT PROVISIONS OF NFPA 72.

FOR NEW CONSTRUCTION AN APPROVED CARBON MONOXIDE ALARM SHALL BE INSTALLED OUTSIDE EACH SEPARATE SLEEPING AREA IN DWELLING UNITS WITHIN WHICH FUEL FIRED APPLIANCES ARE INSTALLED OR HAVE ATTACHED GARAGES.

SINGLE STATION CARBON MONOXIDE ALARMS SHALL BE LISTED AS COMPLYING WITH UL 2034 AND INSTALLED IN ACCORDANCE WITH THIS CODE AND THE MANUFACTURER'S INSTALLATION INSTRUCTIONS.

PROVIDE #10 MINIMUM ELECTRICAL CONDUIT FOR FUTURE PHOTOVOLTAIC PANEL INSTALLATION FROM THE ATTIC TO JUNCTION BOX NEAR THE ELECTRICAL PANEL...

SPECIAL NOTICE

ANY DISCREPANCY IN DIMENSIONS AND/OR DRAWINGS AND/OR GRAPHIC REPRESENTATION AND/OR FIELD MEASUREMENTS SHALL BE BROUGHT TO THE ATTENTION OF BRIDGER ENGINEERING & DESIGN PRIOR TO COMMENCEMENT OF ANY WORK.

ALL SOILS ISSUES SHOULD BE BROUGHT TO THE ATTENTION OF THE SOILS ENGINEER. THE OWNER OR HIS REPRESENTATIVE ARE REQUIRED TO GIVE A SIMPLE NOTICE TO THE SOILS ENGINEER, CONTACTING THE SOILS ENGINEER AND FOLLOWING THEIR RECOMMENDATIONS AND TO HAVE READ THE SOILS REPORT AND RECOGNIZE THE RISKS AND LIMITATIONS STATED THEREIN.

CONTACT THE SOILS ENGINEER AT TIME OF EXCAVATION TO VERIFY THAT ALL STRUCTURAL CONCRETE IS PLACED ON SUITABLE BEARING MATERIAL.

BUILDERS PLANS

THE CONTRACTOR WARRANTS TO BRIDGER ENGINEERING & DESIGN THAT HE POSSESSES THE COMPLETE COMPETENCE AND SKILL IN CONSTRUCTION NECESSARY TO BUILD THIS PROJECT WITHOUT FULL DESIGN SERVICES, AND FOR THE REASON THAT THE CONTRACTOR WISHES TO RELY UPON HIS OWN COMPETENCE, THE CONTRACTOR OR OWNER HAS RESTRICTED BRIDGER ENGINEERING & DESIGN'S SCOPE OF PROFESSIONAL SERVICES. IN RELIANCE ON THE CONTRACTOR'S WARRANTY AND AT THE EXPRESS REQUEST OF THE CONTRACTOR OR OWNER BRIDGER ENGINEERING & DESIGN HAS UNDERTAKEN A LIMITED SCOPE OF PROFESSIONAL SERVICES. THE CONSTRUCTION DOCUMENTS PROVIDED BY THE LIMITED SERVICES SHALL BE TERMED "BUILDER'S PLANS" IN RECOGNITION OF THE CONTRACTOR'S SOPHISTICATED CONSTRUCTION WILL REQUIRE THAT THE CONTRACTOR ADAPT THE "BUILDER'S PLANS" TO THE FIELD CONDITIONS ENCOUNTERED AND MAKE LOGICAL ADJUSTMENT IN FIT, FORM, DIMENSION AND QUANTITY THAT IS NOT HEAVILY DEPENDENT ON THE CONTRACTOR'S PLANS IN THE EVENT ADDITIONAL DETAILS OR GUIDANCE ARE NEEDED BY THE CONTRACTOR OR OWNER, FOR CONSTRUCTION OR ANY ASPECT OF THE PROJECT, HE SHALL IMMEDIATELY NOTIFY BRIDGER ENGINEERING & DESIGN. A SIMPLE NOTICE SHALL RELIEVE BRIDGER ENGINEERING & DESIGN OF RESPONSIBILITY FOR THE CONSEQUENCES.

TABLE R602.5(1) FASTENING SCHEDULE. Table with 4 columns: ITEM, DESCRIPTION OF BUILDING ELEMENTS, NUMBER AND TYPE OF FASTENER, SPACING AND LOCATION. Contains rows 1-13.

Table with 4 columns: ITEM, DESCRIPTION OF BUILDING ELEMENTS, NUMBER AND TYPE OF FASTENER, SPACING AND LOCATION. Contains rows 14-23.

Table with 4 columns: ITEM, DESCRIPTION OF BUILDING ELEMENTS, NUMBER AND TYPE OF FASTENER, SPACING AND LOCATION. Contains rows 24-26.

Table with 4 columns: ITEM, DESCRIPTION OF BUILDING ELEMENTS, NUMBER AND TYPE OF FASTENER, SPACING AND LOCATION. Contains rows 27-39.

FIGURE R507.2.1(1) PLACEMENT OF LAG SCREWS AND BOLTS IN LEDGERS

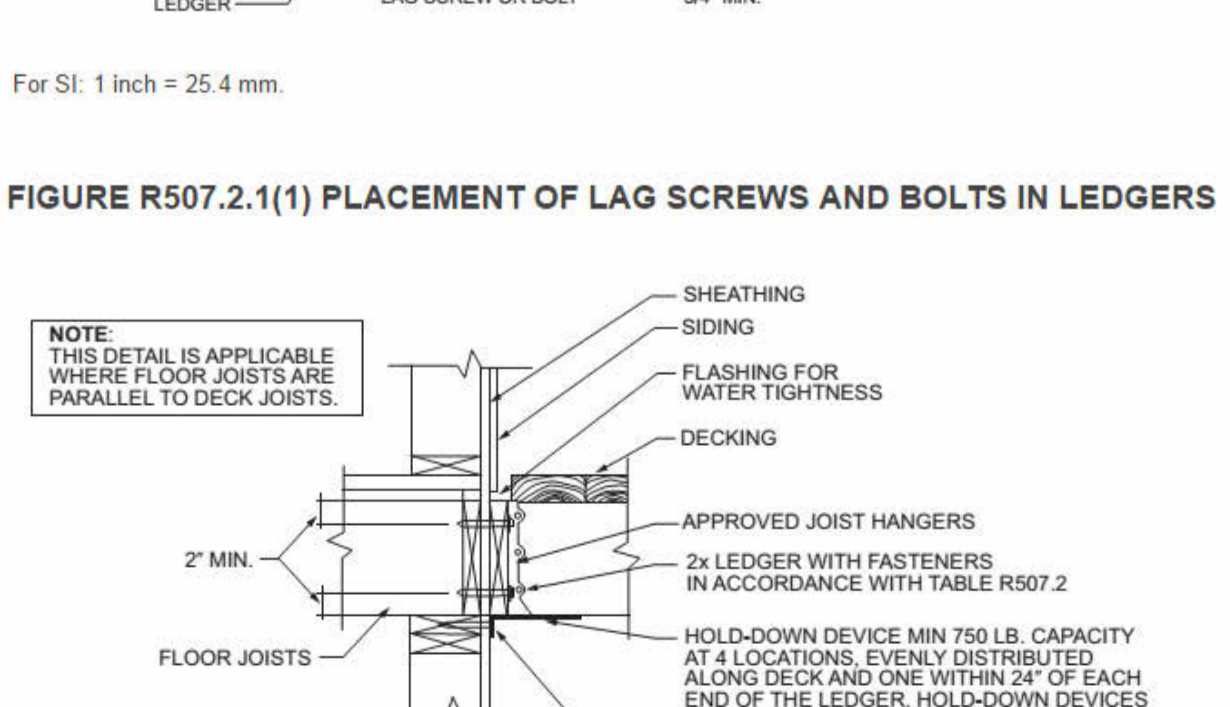


FIGURE R507.2.1(2) PLACEMENT OF LAG SCREWS AND BOLTS IN BAND JOISTS


SHERIDAN WYOMING 307-752-9146 BRIDGER ENGINEERING AND DESIGN BE AND DESIGN

Professional Engineer WYLE A. BRIDGER 17110 Date 2022-11-16 WYOMING "STRUCTURE ONLY"

GLOCK RESIDENCE 30 GENEVA LN SHERIDAN, WY 82801 OWNER/CONTRACTOR 480.239.6512 SPECIFICATIONS

Job # 2022-22 File 22.022 Date 2022.10.24 Drawn KAB Checked KAB Rev'd 20-17-2022

Sheet Number SP2 SHEET 3 OF 14

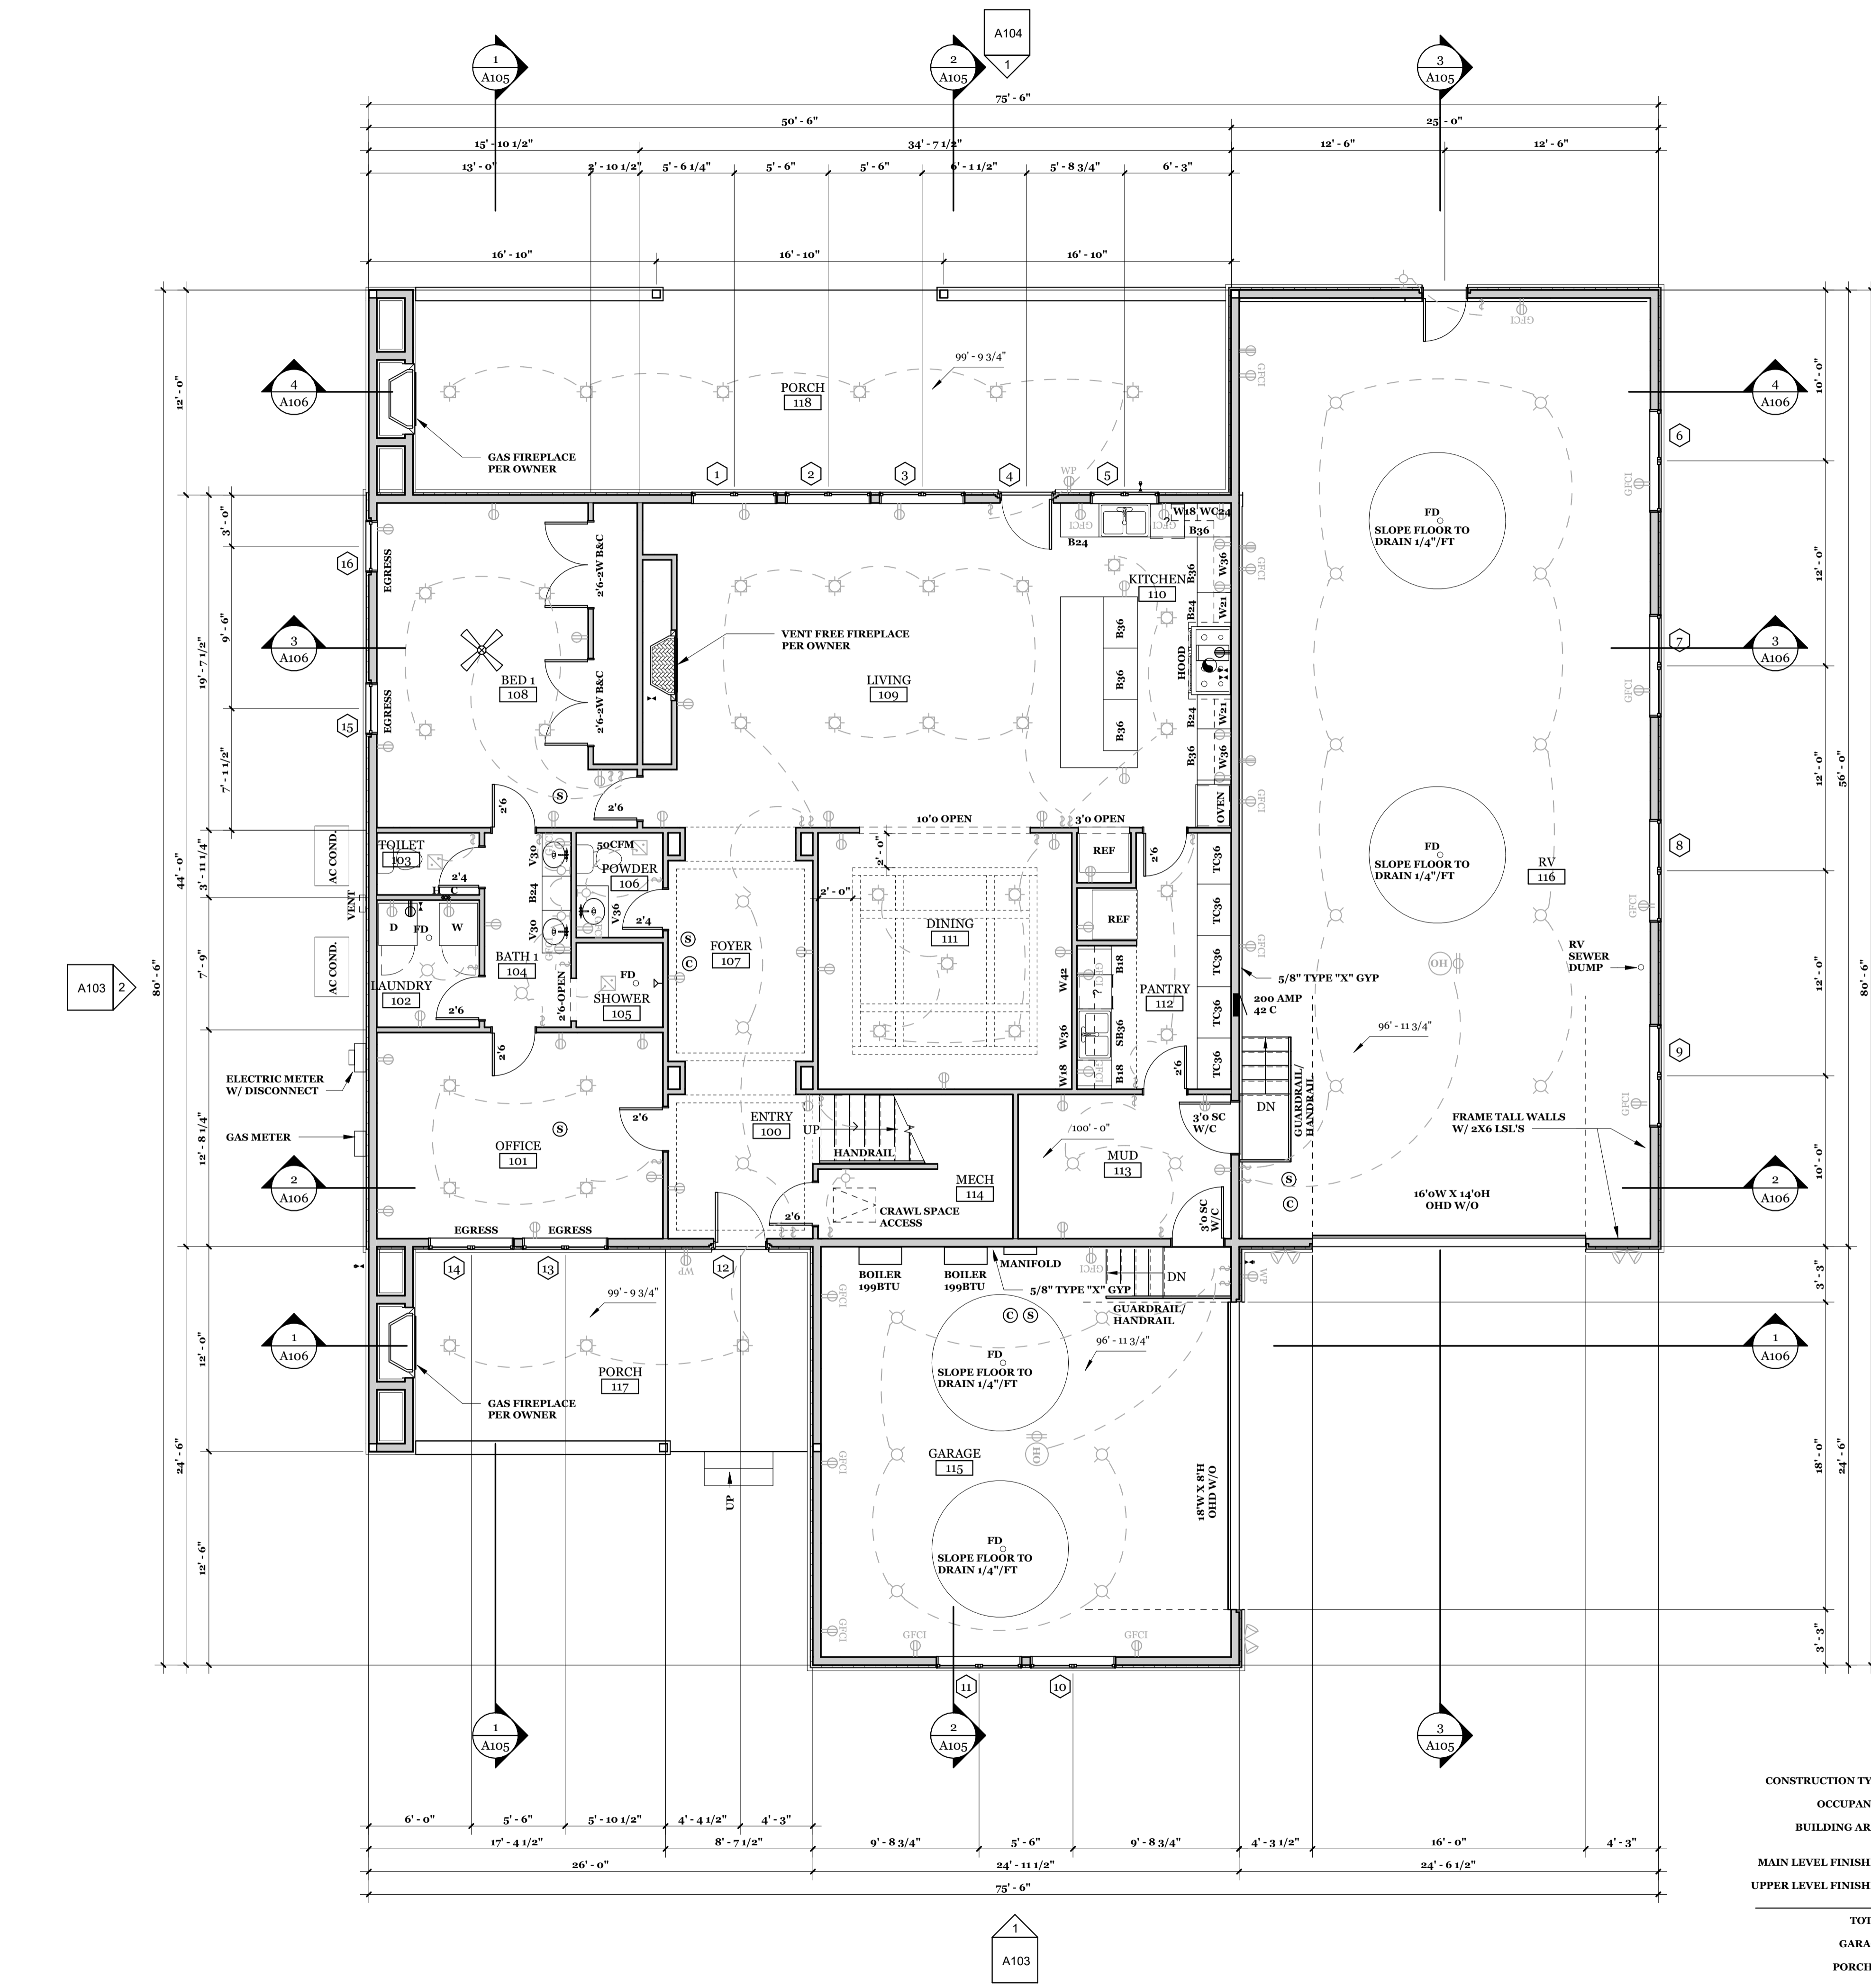

1ST FLOOR PLAN
SCALE: 3/16" = 1'-0"

CONSTRUCTION TYPE: VB
 OCCUPANCY: R3, U1
 BUILDING AREAS
 MAIN LEVEL FINISHED: 2,242 SQ FT
 UPPER LEVEL FINISHED: 2,242 SQ FT
 TOTAL: 4,484 SQ FT
 GARAGE: 1,990 SQ FT
 PORCHES: 918 SQ FT

FINISH SCHEDULE							Finish Notes
Number	Name	Base Finish	Floor Finish	Wall Finish	Ceiling Finish		
100	ENTRY	WOOD	LVT	1/2" GYP BD	1/2" GYP BD		
101	OFFICE	WOOD	LVT	1/2" GYP BD	1/2" GYP BD		
102	LAUNDRY	TILE	LVT	1/2" GYP BD	1/2" GYP BD		
103	TOILET	TILE	TILE	1/2" GYP BD	1/2" GYP BD		BACKERBOARD IN LIEU OF GYP AT WALL TILE LOCATIONS
104	BATH 1	TILE	TILE	1/2" GYP BD	1/2" GYP BD		BACKERBOARD IN LIEU OF GYP AT WALL TILE LOCATIONS
105	SHOWER	TILE	TILE	1/2" GYP BD	1/2" GYP BD		BACKERBOARD IN LIEU OF GYP AT WALL TILE LOCATIONS
106	POWDER	TILE	TILE	1/2" GYP BD	1/2" GYP BD		BACKERBOARD IN LIEU OF GYP AT WALL TILE LOCATIONS
107	FOYER	WOOD	LVT	1/2" GYP BD	1/2" GYP BD		
108	BED 1	WOOD	LVT	1/2" GYP BD	1/2" GYP BD		
109	LIVING	WOOD	LVT	1/2" GYP BD	1/2" GYP BD		
110	KITCHEN	WOOD	LVT	1/2" GYP BD	1/2" GYP BD		
111	DINING	WOOD	LVT	1/2" GYP BD	1/2" GYP BD		
112	PANTRY	WOOD	LVT	1/2" GYP BD	1/2" GYP BD		
113	MUD	TILE	TILE	1/2" GYP BD	1/2" GYP BD		BACKERBOARD IN LIEU OF GYP AT WALL TILE LOCATIONS
114	MECH	VINYL	LVT	5/8" TYPE "X" GYP BD	5/8" TYPE "X" GYP BD		
115	GARAGE	VINYL	SEALED CONCRETE	5/8" TYPE "X" GYP BD	5/8" TYPE "X" GYP BD		
116	RV	VINYL	SEALED CONCRETE	5/8" TYPE "X" GYP BD	5/8" TYPE "X" GYP BD		
117	PORCH	-	SEALED CONCRETE	-	T&G		
118	PORCH	-	SEALED CONCRETE	-	T&G		
200	HALL	WOOD	CARPET	1/2" GYP BD	1/2" GYP BD		
201	BED 2	WOOD	CARPET	1/2" GYP BD	1/2" GYP BD		
202	BATH 2	TILE	TILE	1/2" GYP BD	1/2" GYP BD		
203	CLOSET	WOOD	CARPET	1/2" GYP BD	1/2" GYP BD		
204	PLAY	WOOD	CARPET	1/2" GYP BD	1/2" GYP BD		
205	CLOSET	WOOD	CARPET	1/2" GYP BD	1/2" GYP BD		
206	BATH 3	TILE	TILE	1/2" GYP BD	1/2" GYP BD		
207	BED 3	WOOD	CARPET	1/2" GYP BD	1/2" GYP BD		
208	CLOSET	WOOD	CARPET	1/2" GYP BD	1/2" GYP BD		
209	MASTER BED	WOOD	CARPET	1/2" GYP BD	1/2" GYP BD		
210	SHOWER	TILE	TILE	1/2" GYP BD	1/2" GYP BD		BACKERBOARD IN LIEU OF GYP AT WALL TILE LOCATIONS
211	MASTER BATH	TILE	TILE	1/2" GYP BD	1/2" GYP BD		
212	MASTER CLOSET	WOOD	CARPET	1/2" GYP BD	1/2" GYP BD		
213	LAUNDRY	TILE	TILE	1/2" GYP BD	1/2" GYP BD		

Window Schedule							Egress	Tempered	AREA
Mark	Type	Level	Width	Height	Head Height				
1	CC3060-2	MAIN LEVEL	5'-0"	5'-0"	8'-0"			25 SF	
2	CC3060-2	MAIN LEVEL	5'-0"	5'-0"	8'-0"			25 SF	
3	CC3060-2	MAIN LEVEL	5'-0"	5'-0"	8'-0"			25 SF	
4	UWFD3080	MAIN LEVEL	3'-1 7/16"	7'-11 1/2"	7'-11 1/2"			25 SF	
5	CC2448-2	MAIN LEVEL	4'-0"	4'-0"	8'-0"			16 SF	
6	CC3636-2	TOS GARAGE	6'-0"	3'-0"	12'-0"			18 SF	
7	CC3636-2	TOS GARAGE	6'-0"	3'-0"	12'-0"			18 SF	
8	CC3636-2	TOS GARAGE	6'-0"	3'-0"	12'-0"			18 SF	
9	CC3636-2	TOS GARAGE	6'-0"	3'-0"	12'-0"			18 SF	
10	CC3060-2	MAIN LEVEL	5'-0"	5'-0"	8'-0"			25 SF	
11	CC3060-2	MAIN LEVEL	5'-0"	5'-0"	8'-0"			25 SF	
12	UWFD3080	MAIN LEVEL	3'-1 7/16"	7'-11 1/2"	7'-11 1/2"			25 SF	
13	CC3060-2	MAIN LEVEL	5'-0"	5'-0"	8'-0"		Y	25 SF	
14	CC3060-2	MAIN LEVEL	5'-0"	5'-0"	8'-0"		Y	25 SF	
15	DCS3660	MAIN LEVEL	3'-0"	5'-0"	8'-0"		Y	15 SF	
16	DCS3660	MAIN LEVEL	3'-0"	5'-0"	8'-0"		Y	15 SF	
17	CC2460-2	SECOND LEVEL	4'-0"	5'-0"	8'-0"			20 SF	
18	CC2460-2	SECOND LEVEL	4'-0"	5'-0"	8'-0"			20 SF	
19	CC2460-2	SECOND LEVEL	4'-0"	5'-0"	8'-0"			20 SF	
20	CC2460-2	SECOND LEVEL	4'-0"	5'-0"	8'-0"			20 SF	
21	CC3636-2	SECOND LEVEL	6'-0"	3'-0"	8'-0"			18 SF	
22	CC3660	SECOND LEVEL	3'-0"	5'-0"	8'-0"			15 SF	
23	CC2460-2	SECOND LEVEL	4'-0"	5'-0"	8'-0"			20 SF	
24	CC2460-2	SECOND LEVEL	4'-0"	5'-0"	8'-0"			20 SF	
Grand total:							24		496 SF



VERIFY WITH OWNER ALL FINISHES TO BE INSTALLED WINDOWS TO BE PELLA OR EQ. Uo.30 MAX ALL OPERABLE WINDOWS TO BE SUPPLIED WITH SCREENS

METER	METER W/ DISCONNECT	A/K/A	ALSO KNOWN AS
200A 42C	SERVICE PANEL, SIZE AS NOTED	&	AND
	110 VAC DUPLEX RECEPTACLE	@	AT
GFI	110 VAC DUPLEX RECEPTACLE, GFCI PROTECTED	-OR APPROX	APPROXIMATELY
WP	110 VAC DUPLEX RECEPTACLE, GFCI PROTECTED, WEATHERPROOF	Ø	DIAMETER
	220 VAC RECEPTACLE, AMPERAGE NOTED	EBO	ENGINEERED BY OTHERS
SW	SWITCH	FOC	FACE OF CONCRETE
	LIGHT/ EXHAUST FAN UNIT	FOS	FACE OF STUD OR FRAMING
	RECESSED FIXTURE	FT	FOOT / FEET
	SURFACE MOUNT FIXTURE, DECORATIVE	FFE	FINISH FLOOR ELEVATION
	WALL MOUNT FIXTURE, DECORATIVE	H	HEIGHT
TL	TRACK LIGHT	IN	INCH (ES)
	SMOKE DETECTOR	LVL	LAMINATED-VENEER LUMBER
	CARBON MONOXIDE DETECTOR	MAX	MAXIMUM
	OVERHEAD DOOR OPERATOR	MIN	MINIMUM
	PHOTO CELL W/ MOTION DETECTOR	NTS	NOT TO SCALE
BOILER	BOILER	#	NUMBER
(WH)	WATER HEATER OR SIDE ARM STORAGE TANK	OC	ON CENTER
	FLUE PIPE, SIZE NOTED		PARALLEL
	SHUT OFF VALVE	T OR PERP	PERPENDICULAR
	HOSE BIB, FROST PROOF	# OR LB	POUNDS
WASHER VALVE & DRAIN BOX	WASHER VALVE & DRAIN BOX	PSF	POUNDS PER SQUARE FOOT
		PSI	POUNDS PER SQUARE INCH
		PT OR CCA	PRESSURE TREATED
		REBAR	REINFORCING STEEL
		REQ'D	REQUIRED
		R.N.R.	RECOMMENDED NOT REQUIRED
		OR SQ FT	SQUARE FOOT / FEET
		T&G	TONGUE AND GROOVE
		T&B	TOP AND BOTTOM
		TYP	TYPICAL
		UNON	UNLESS OTHERWISE NOTED
		W	WIDTH
		W/	WITH
		WWM	WELDED WIRE MESH
		O	QUANTITY

LIST OF ABBREVIATIONS
SCALE: 3/16" = 1'-0"

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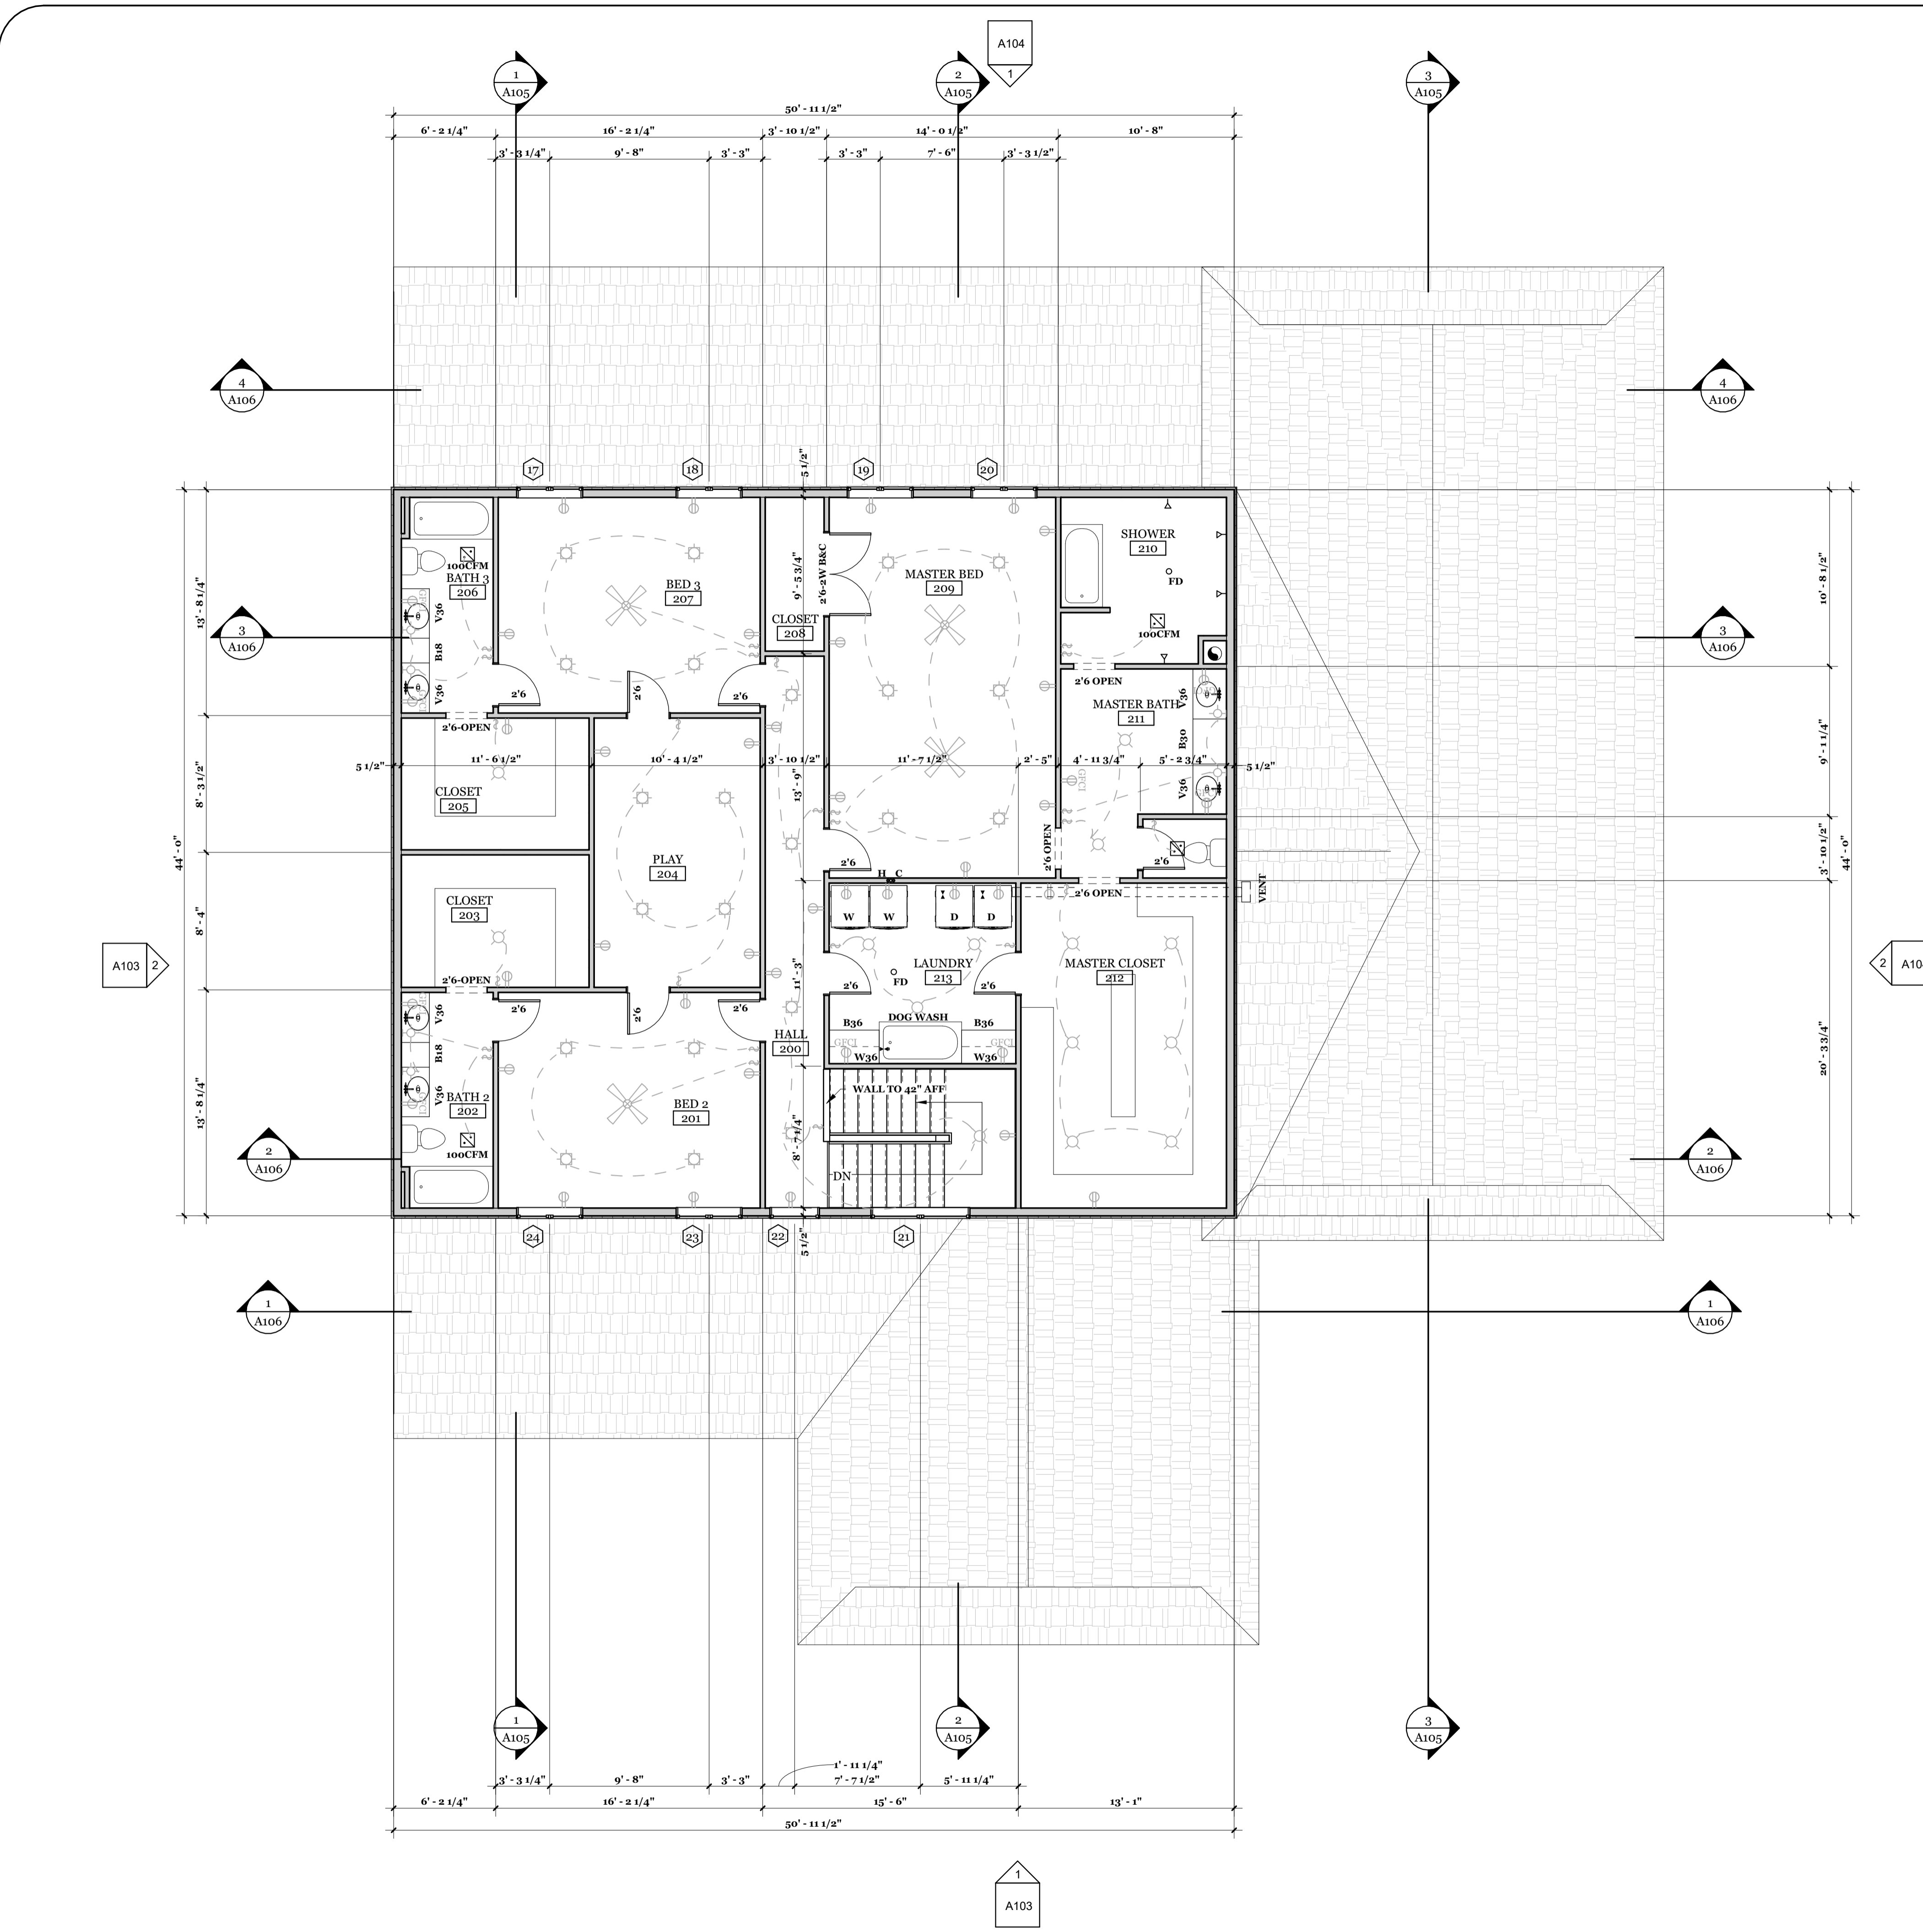


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MAIN LEVEL FLOOR PLAN
GLOCK RESIDENCE
 30 GENEVA LN
 SHERIDAN, WY 82801
 OWNER/CONTRACTOR 480.239.6512

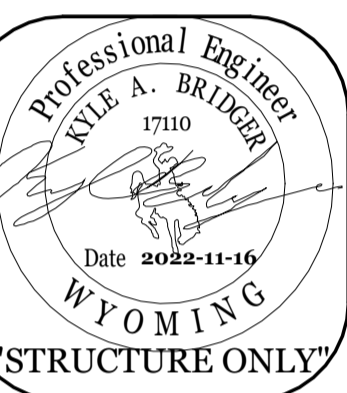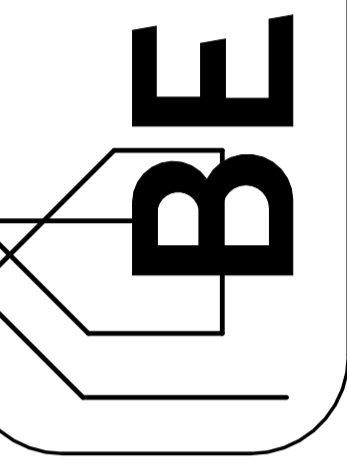Job # 2022-22
 File 22.022
 Date 2022.10.24
 Drawn KAB
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 Rev'd 20-17-2022

Sheet Number
A100
 SHEET 4 OF 14




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A101
2ND FLOOR PLAN
 SCALE: 3/16" = 1'-0"

ALL DOORS TO BE 8'-0" TALL UNLESS NOTED OTHERWISE

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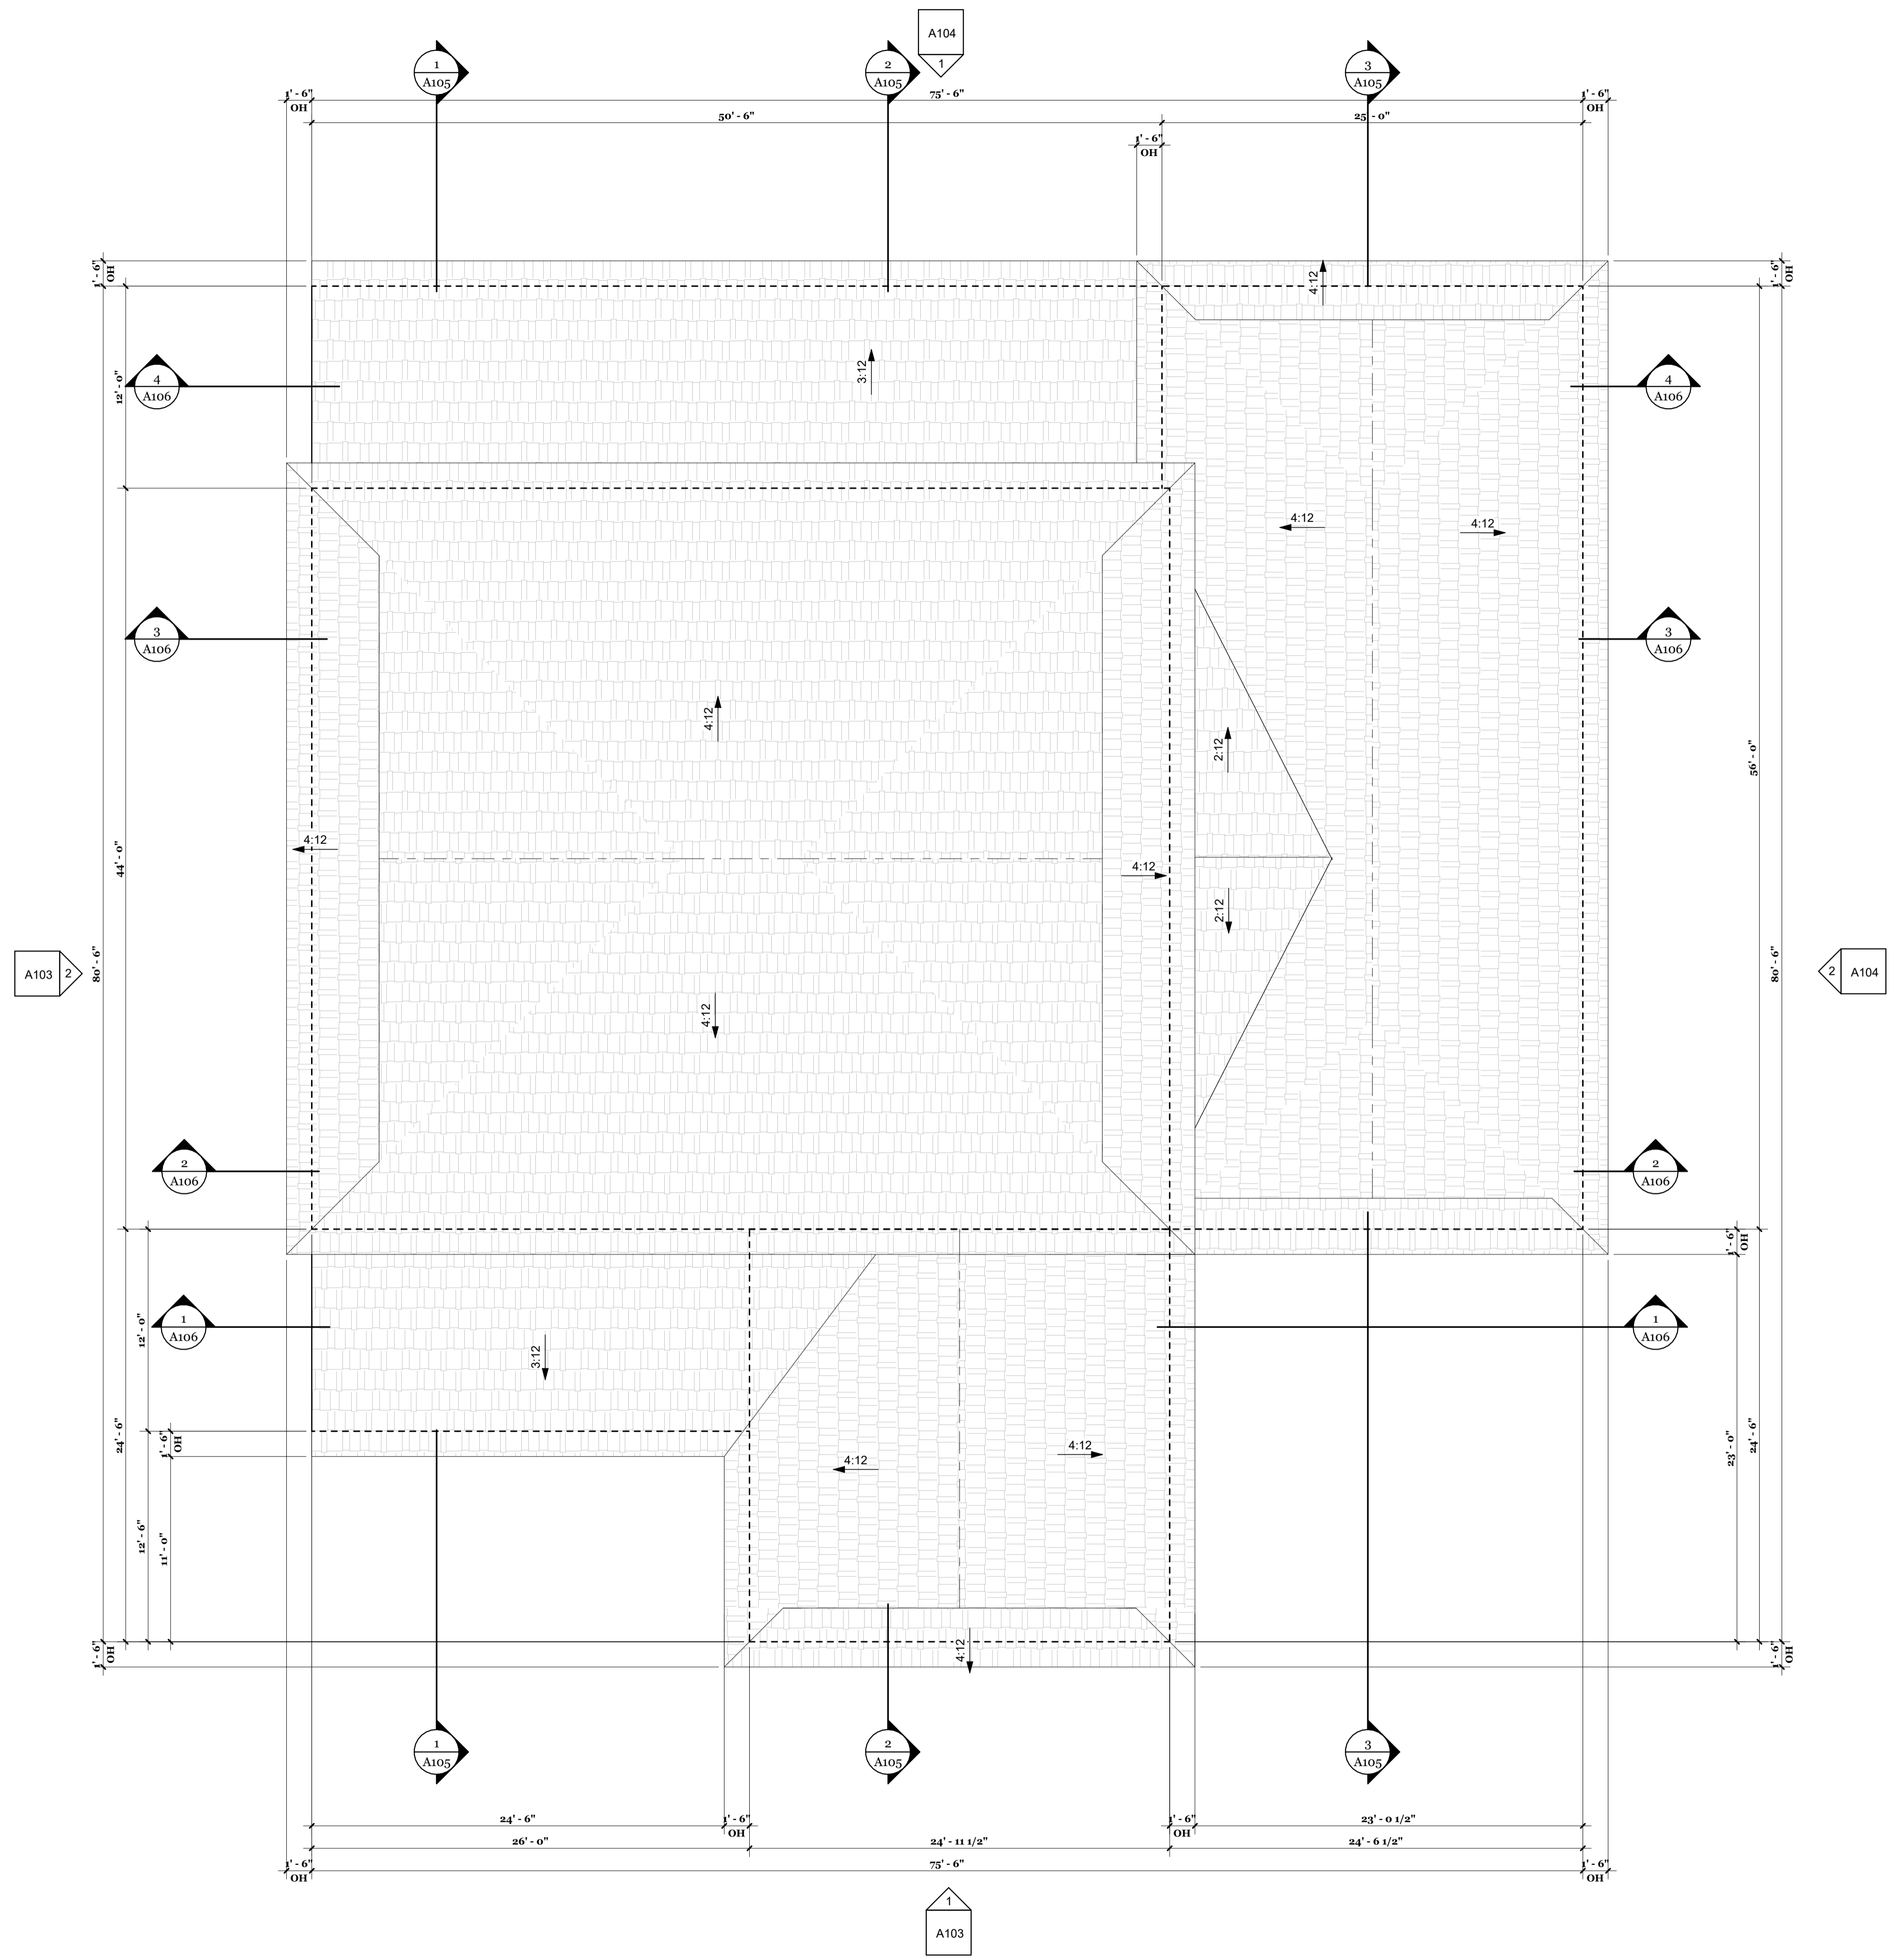


UPPER LEVEL FLOOR PLAN

GLOCK RESIDENCE
 30 GENEVA LN
 SHERIDAN, WY 82801
 OWNER/CONTRACTOR 480.239.6512

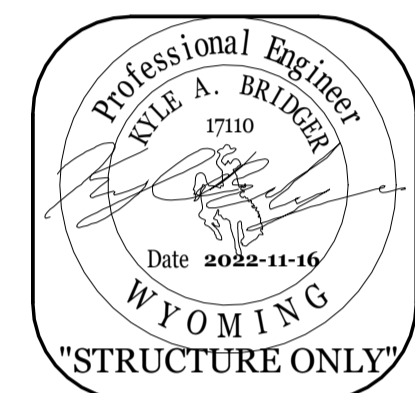Job # 2022-22
 File 22.022
 Date 2022.10.24
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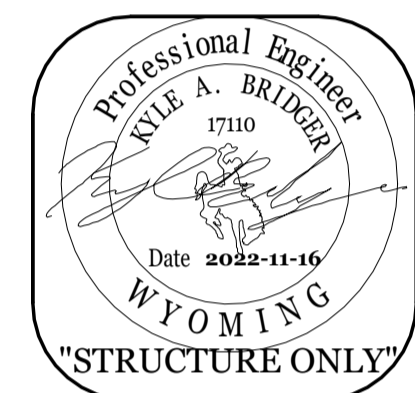
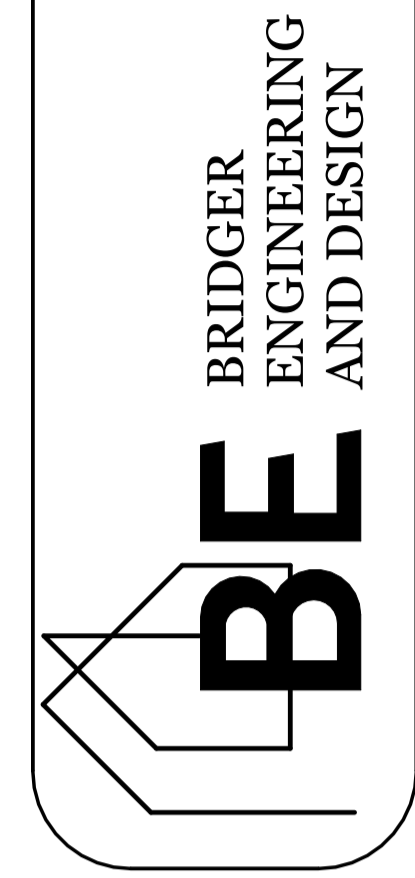
Sheet Number
A101
 SHEET 5 OF 14



1 OVERALL ROOF PLAN
A102 SCALE: 3/16" = 1'-0"

NOTE:
ALL ROOFS TO BE CLAY TILE OR
PER OWNER


SHERIDAN
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307-752-9146




ROOF PLAN
GLOCK RESIDENCE
30 GENEVA LN
SHERIDAN, WY 82801
OWNER/CONTRACTOR 480.239.6512

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File 22.022
Date 2022.10.24
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Rel'd 20-17-2022
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Sheet Number
A102
SHEET 6 OF 14

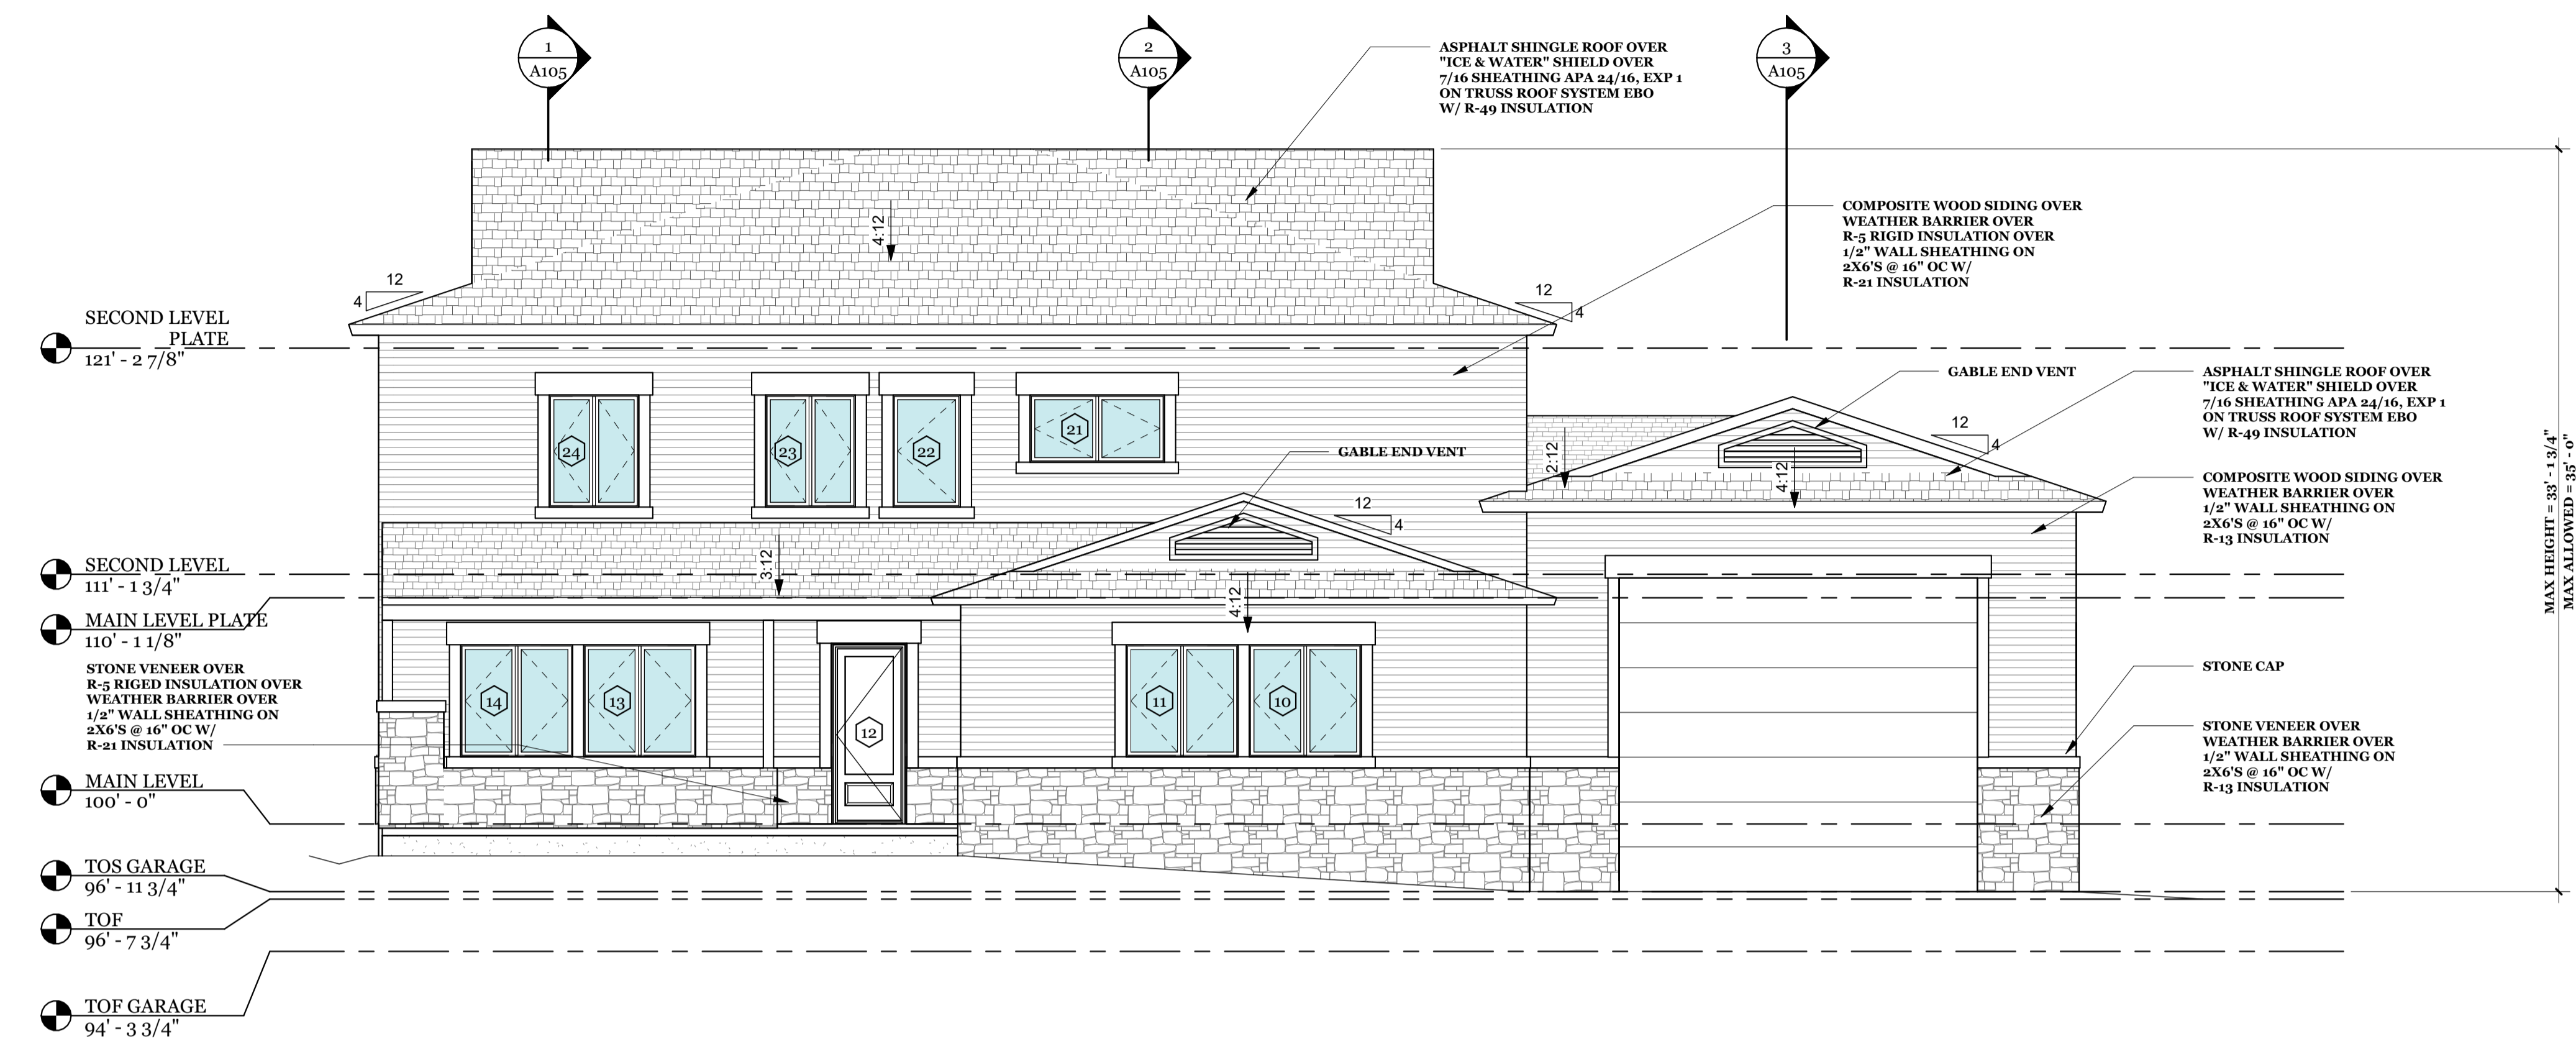

1 SOUTH ELEVATION
A103 SCALE: 3/16" = 1'-0"

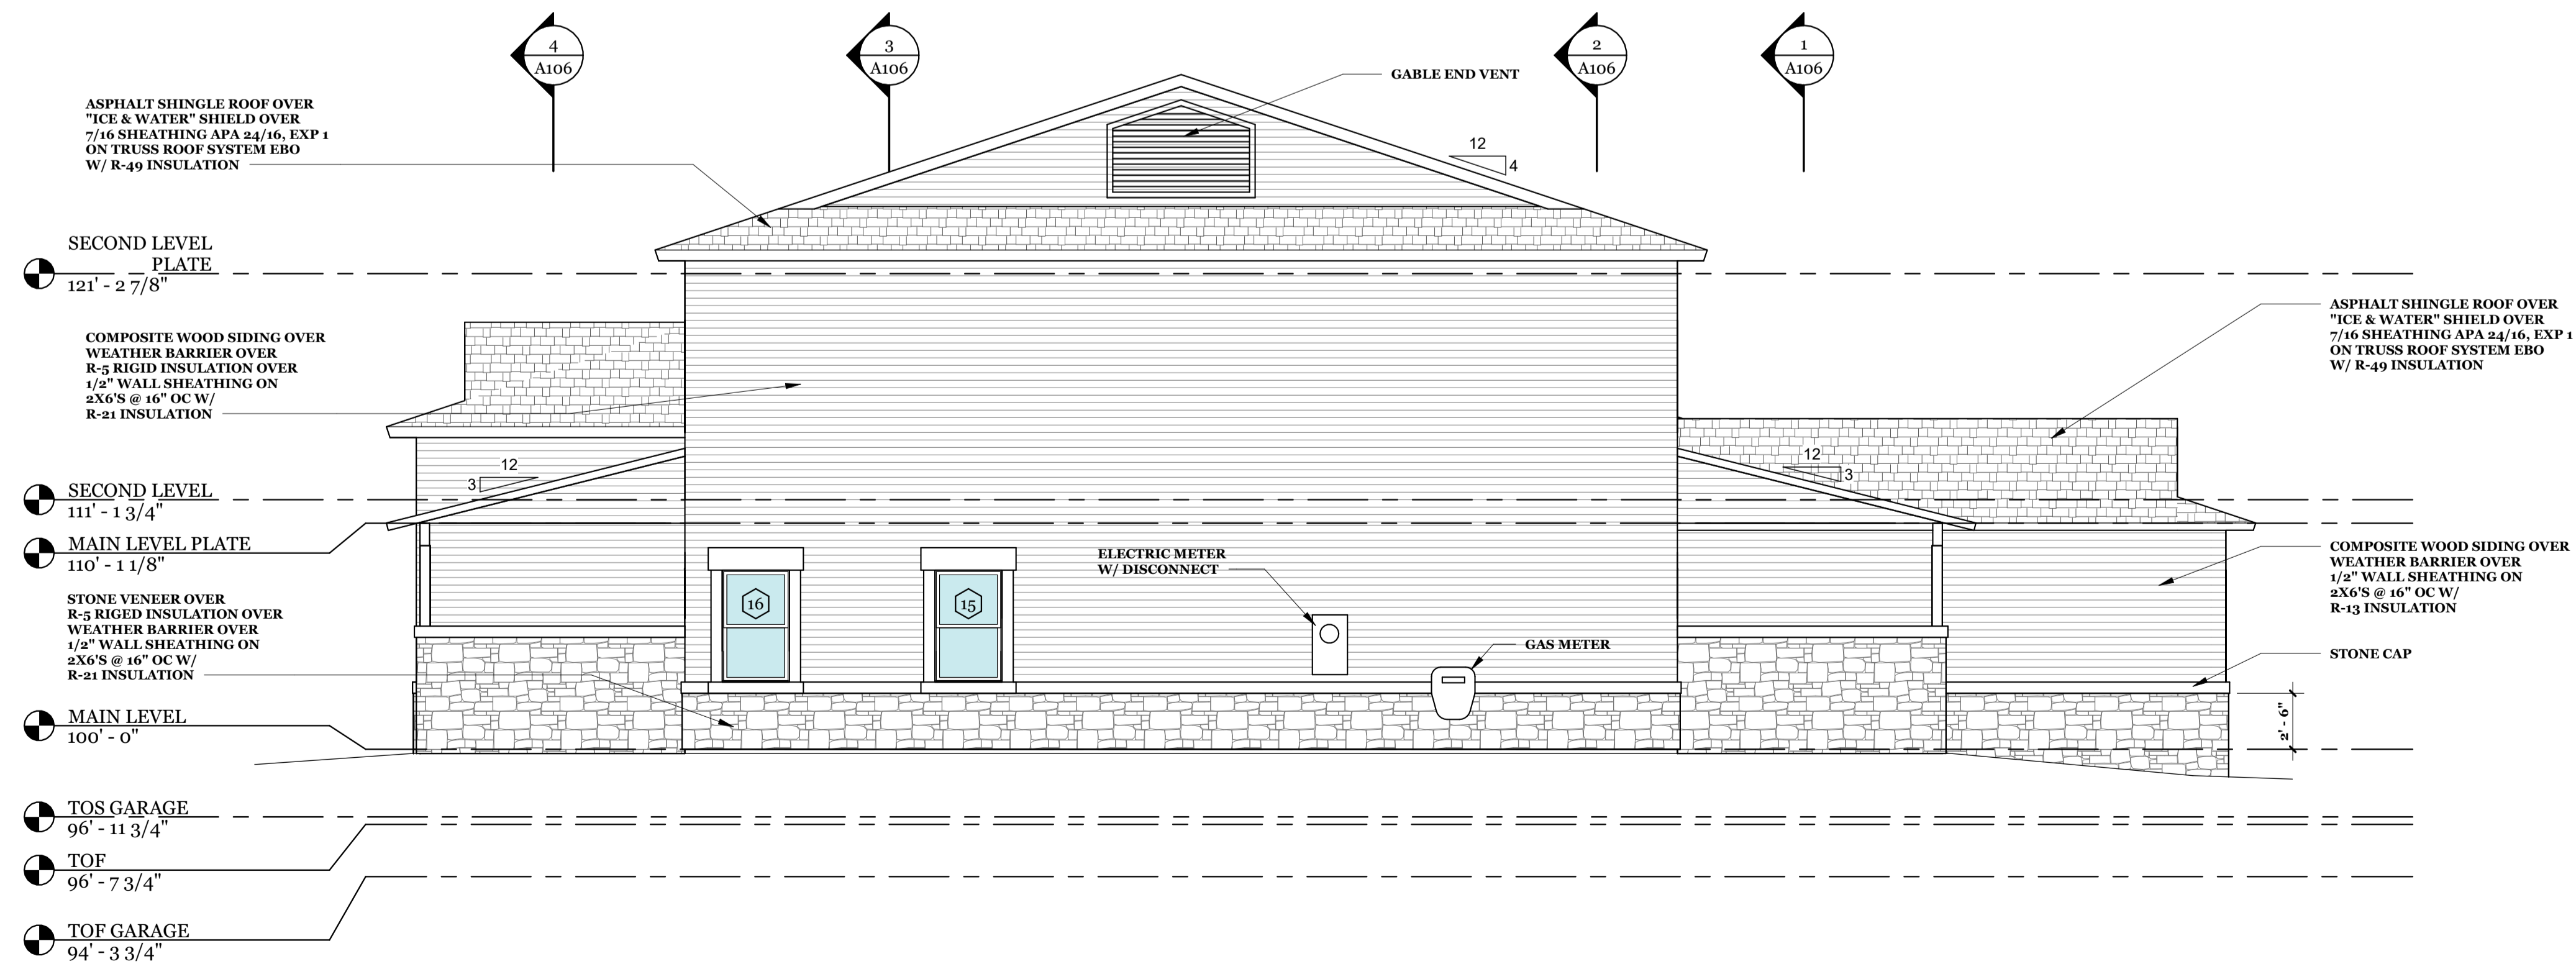


2 WEST ELEVATION
A103 SCALE: 3/16" = 1'-0"

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BUILDING ELEVATIONS

GLOCK RESIDENCE

30 GENEVA LN
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OWNER/CONTRACTOR 480.239.6512

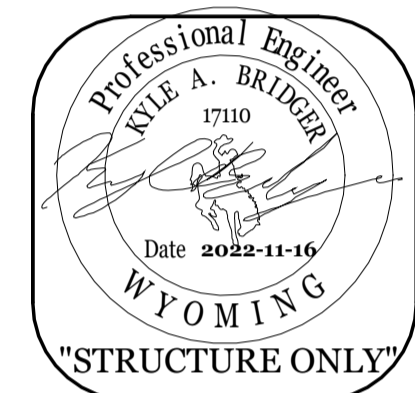
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Date 2022.10.24
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Sheet Number
A103
SHEET 7 OF 14

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1 NORTH ELEVATION
A104/SCALE: 3/16" = 1'-0"




2 EAST ELEVATION
A104/SCALE: 3/16" = 1'-0"

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BUILDING ELEVATIONS

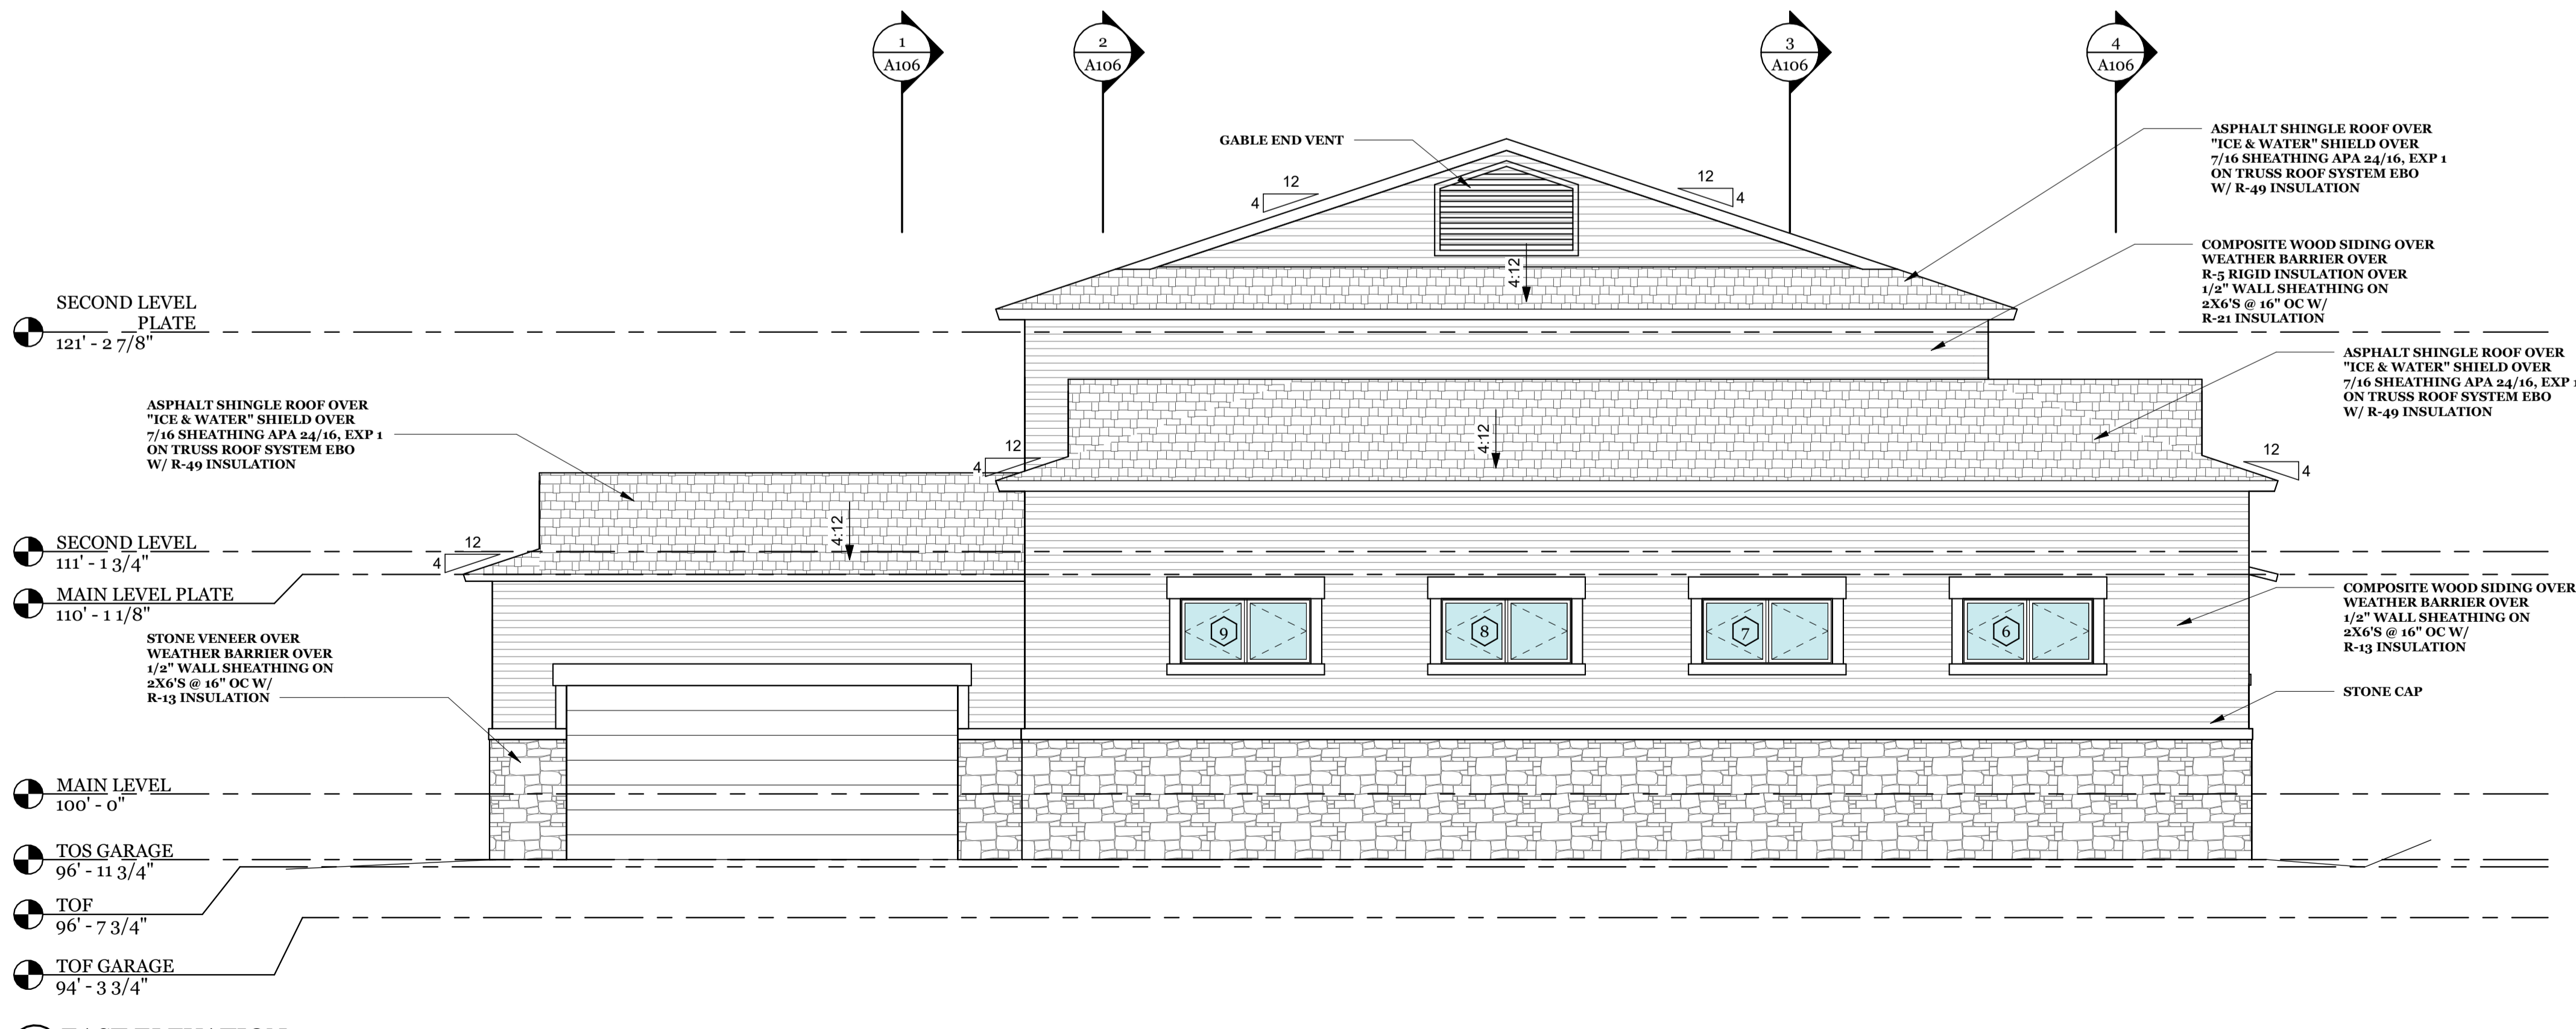GLOCK RESIDENCE




30 GENEVA LN
SHERIDAN, WY 82801
OWNER/CONTRACTOR 480.239.6512

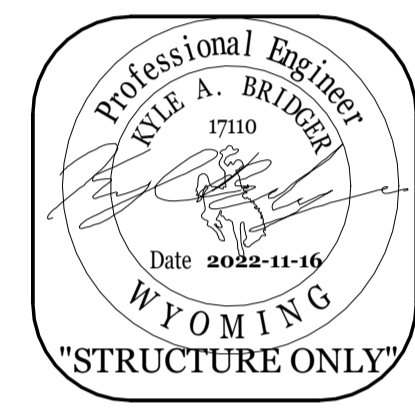Job #	2022-22
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Sheet Number

A104

SHEET 8 OF 14

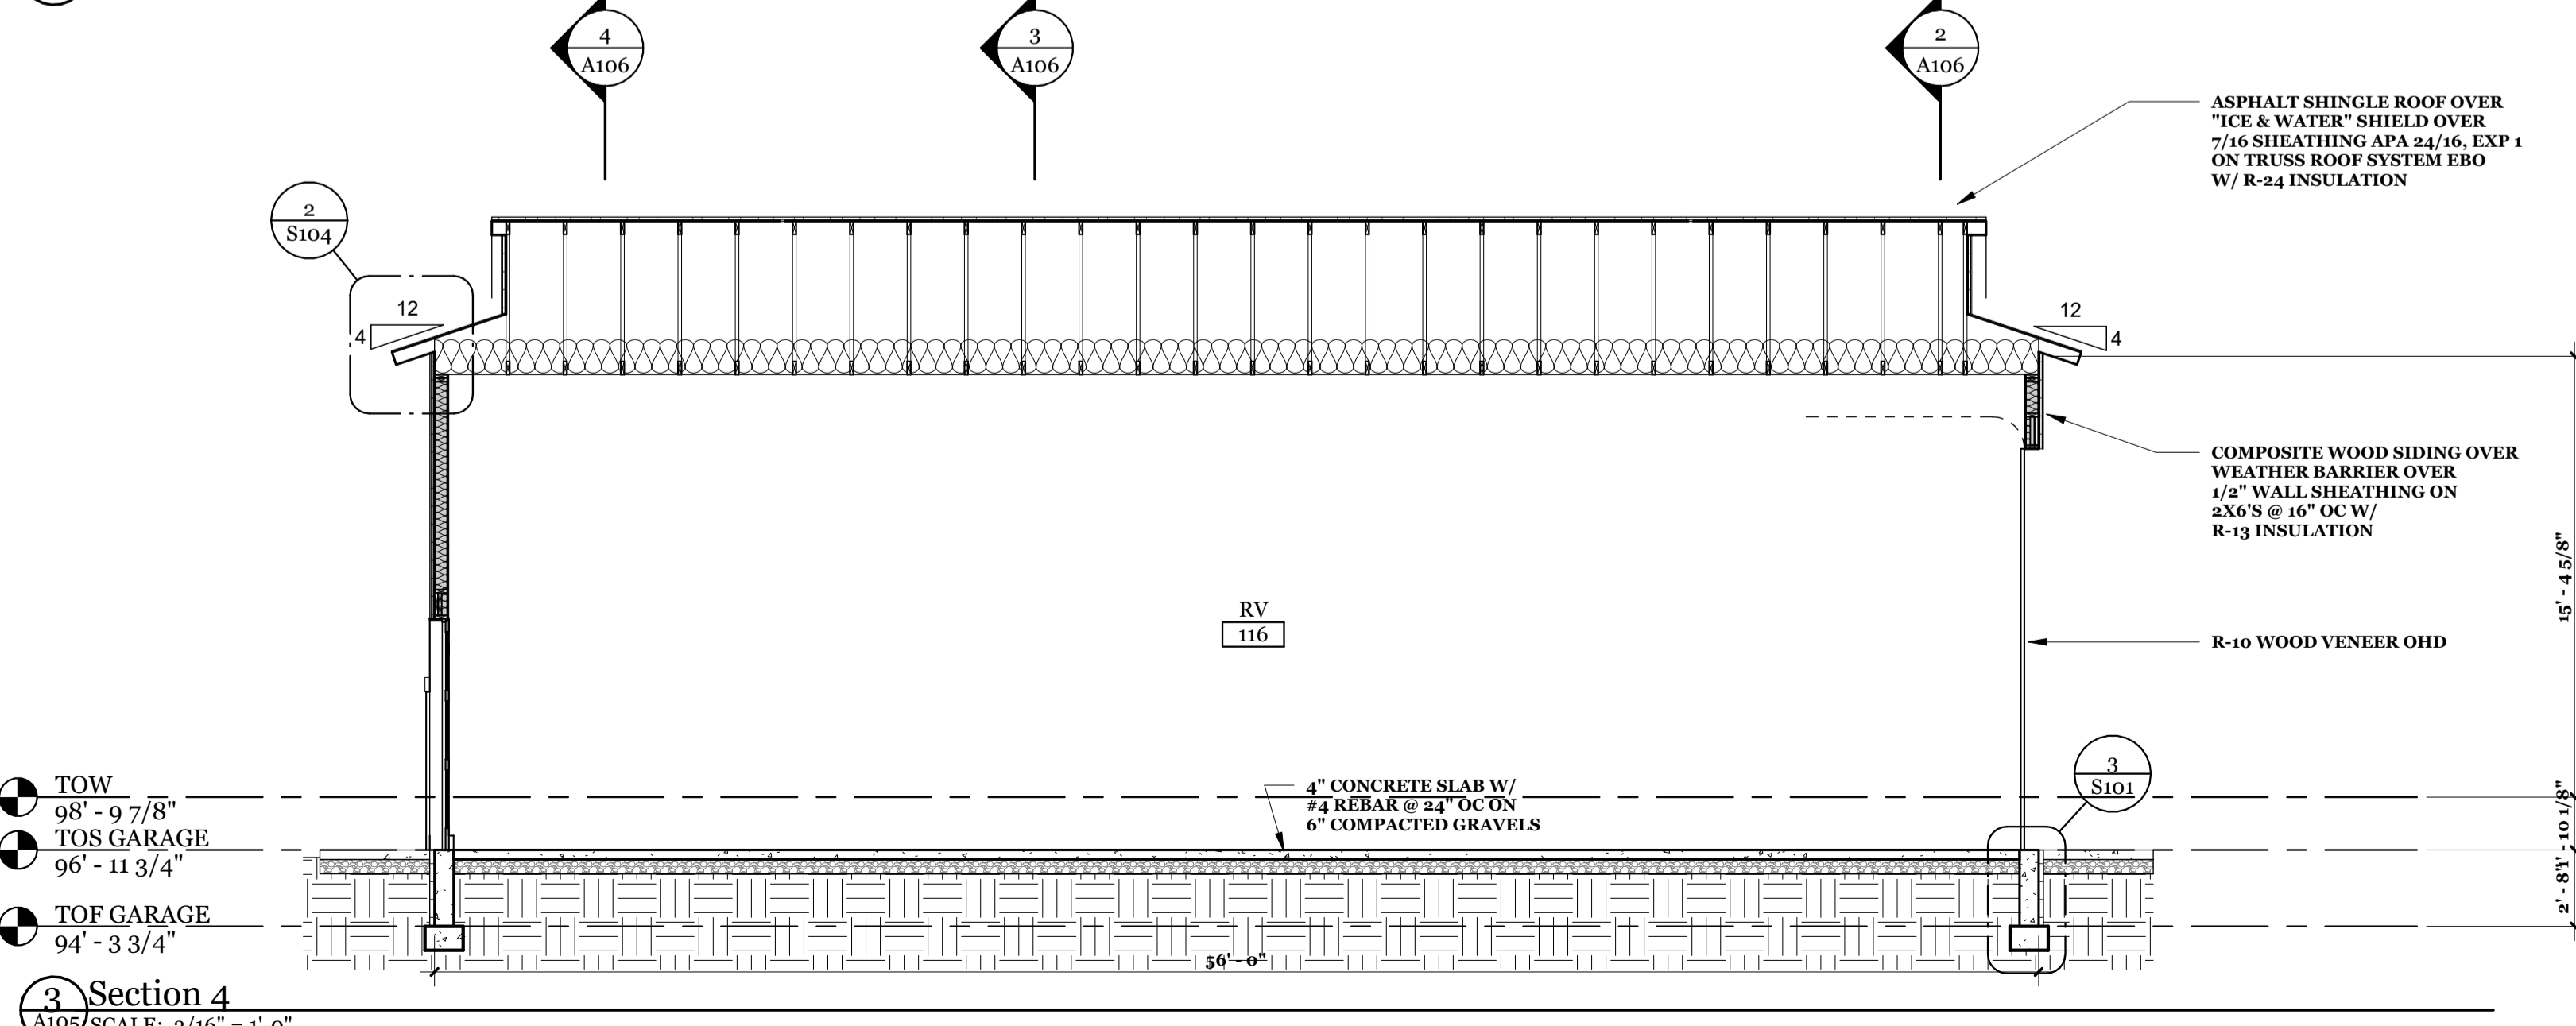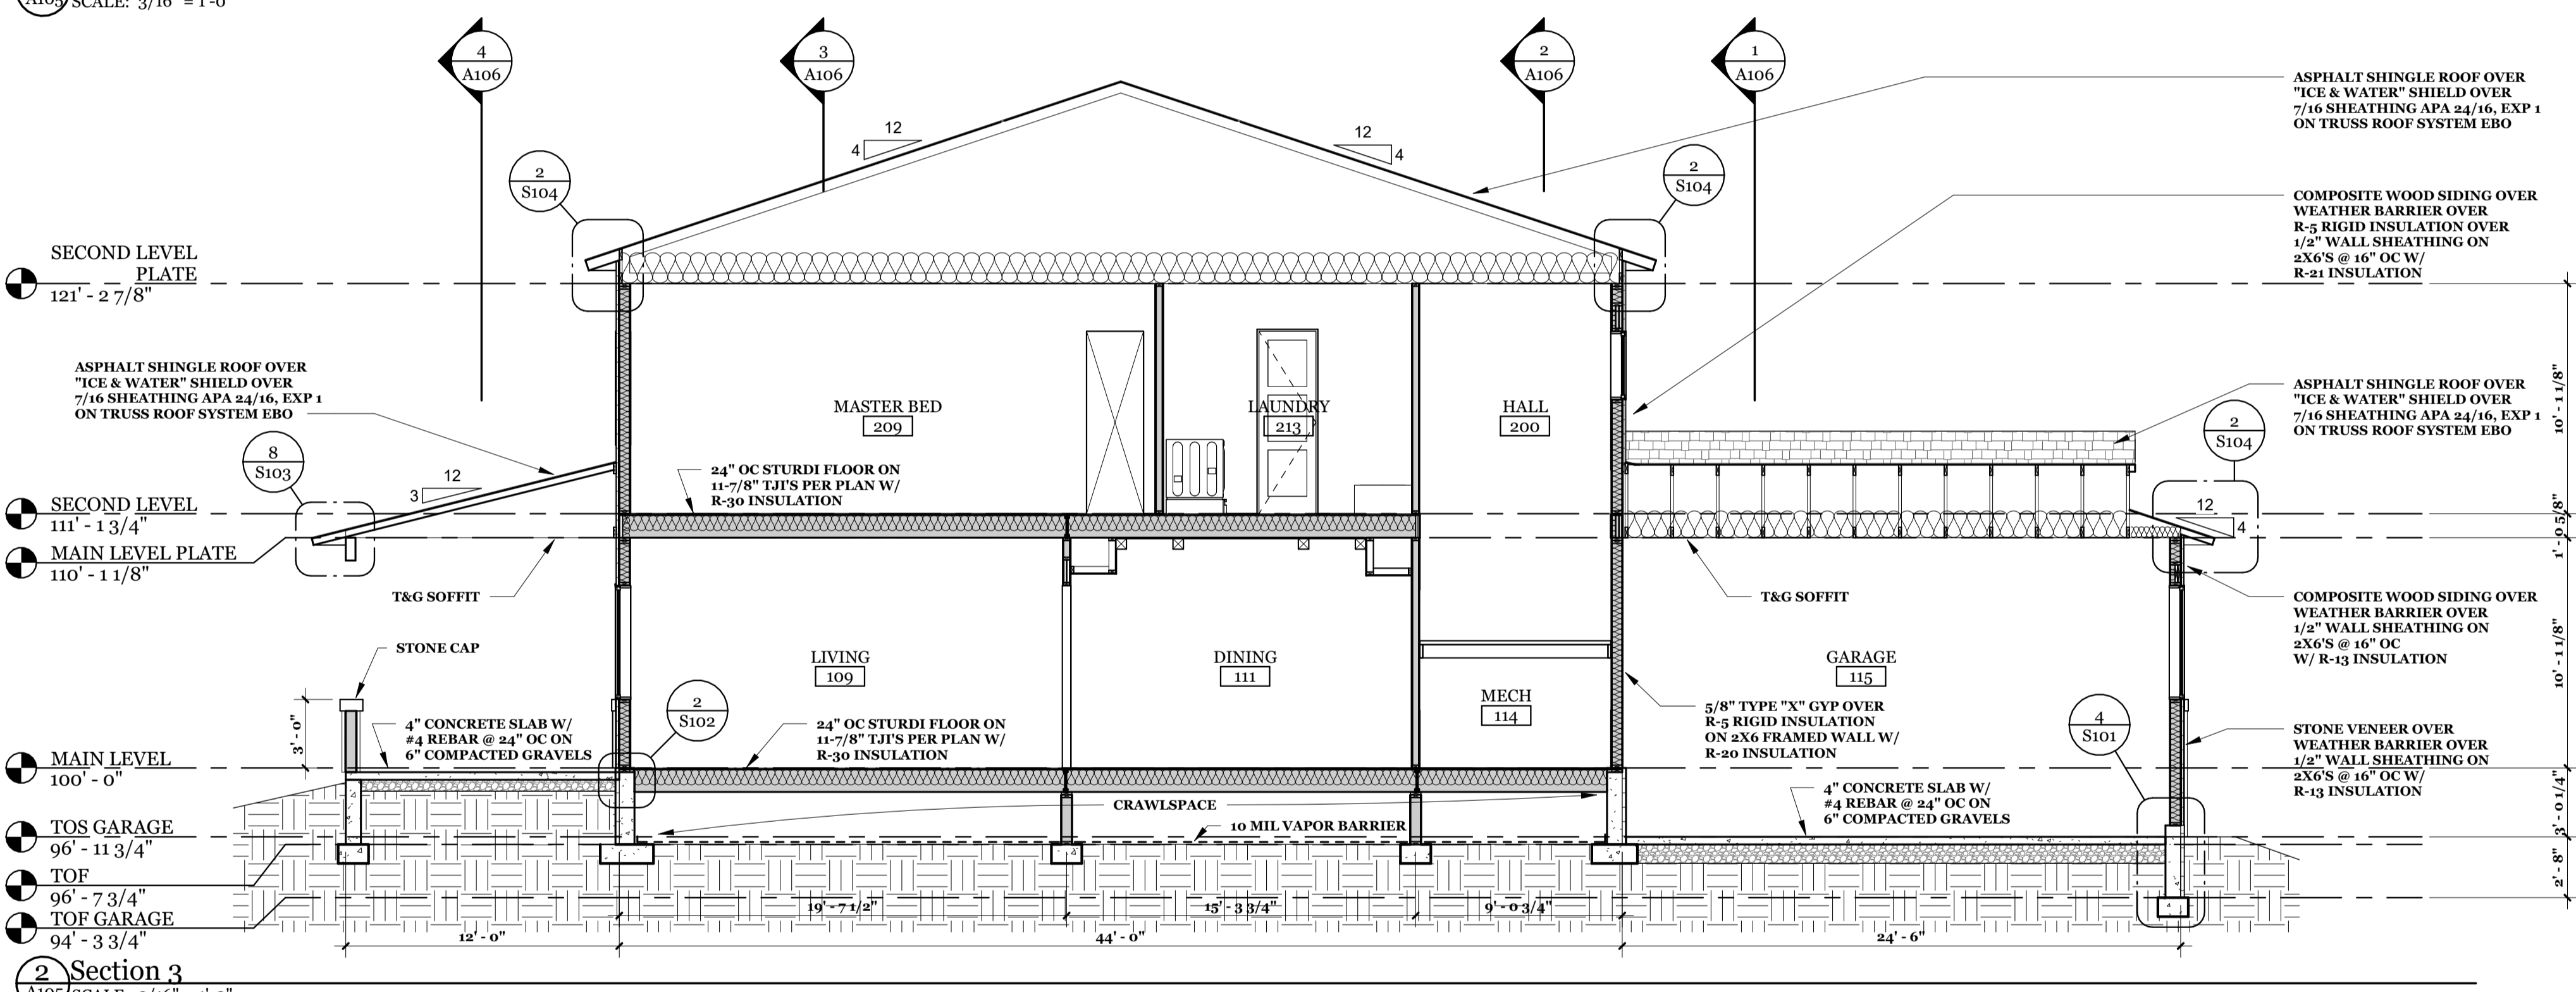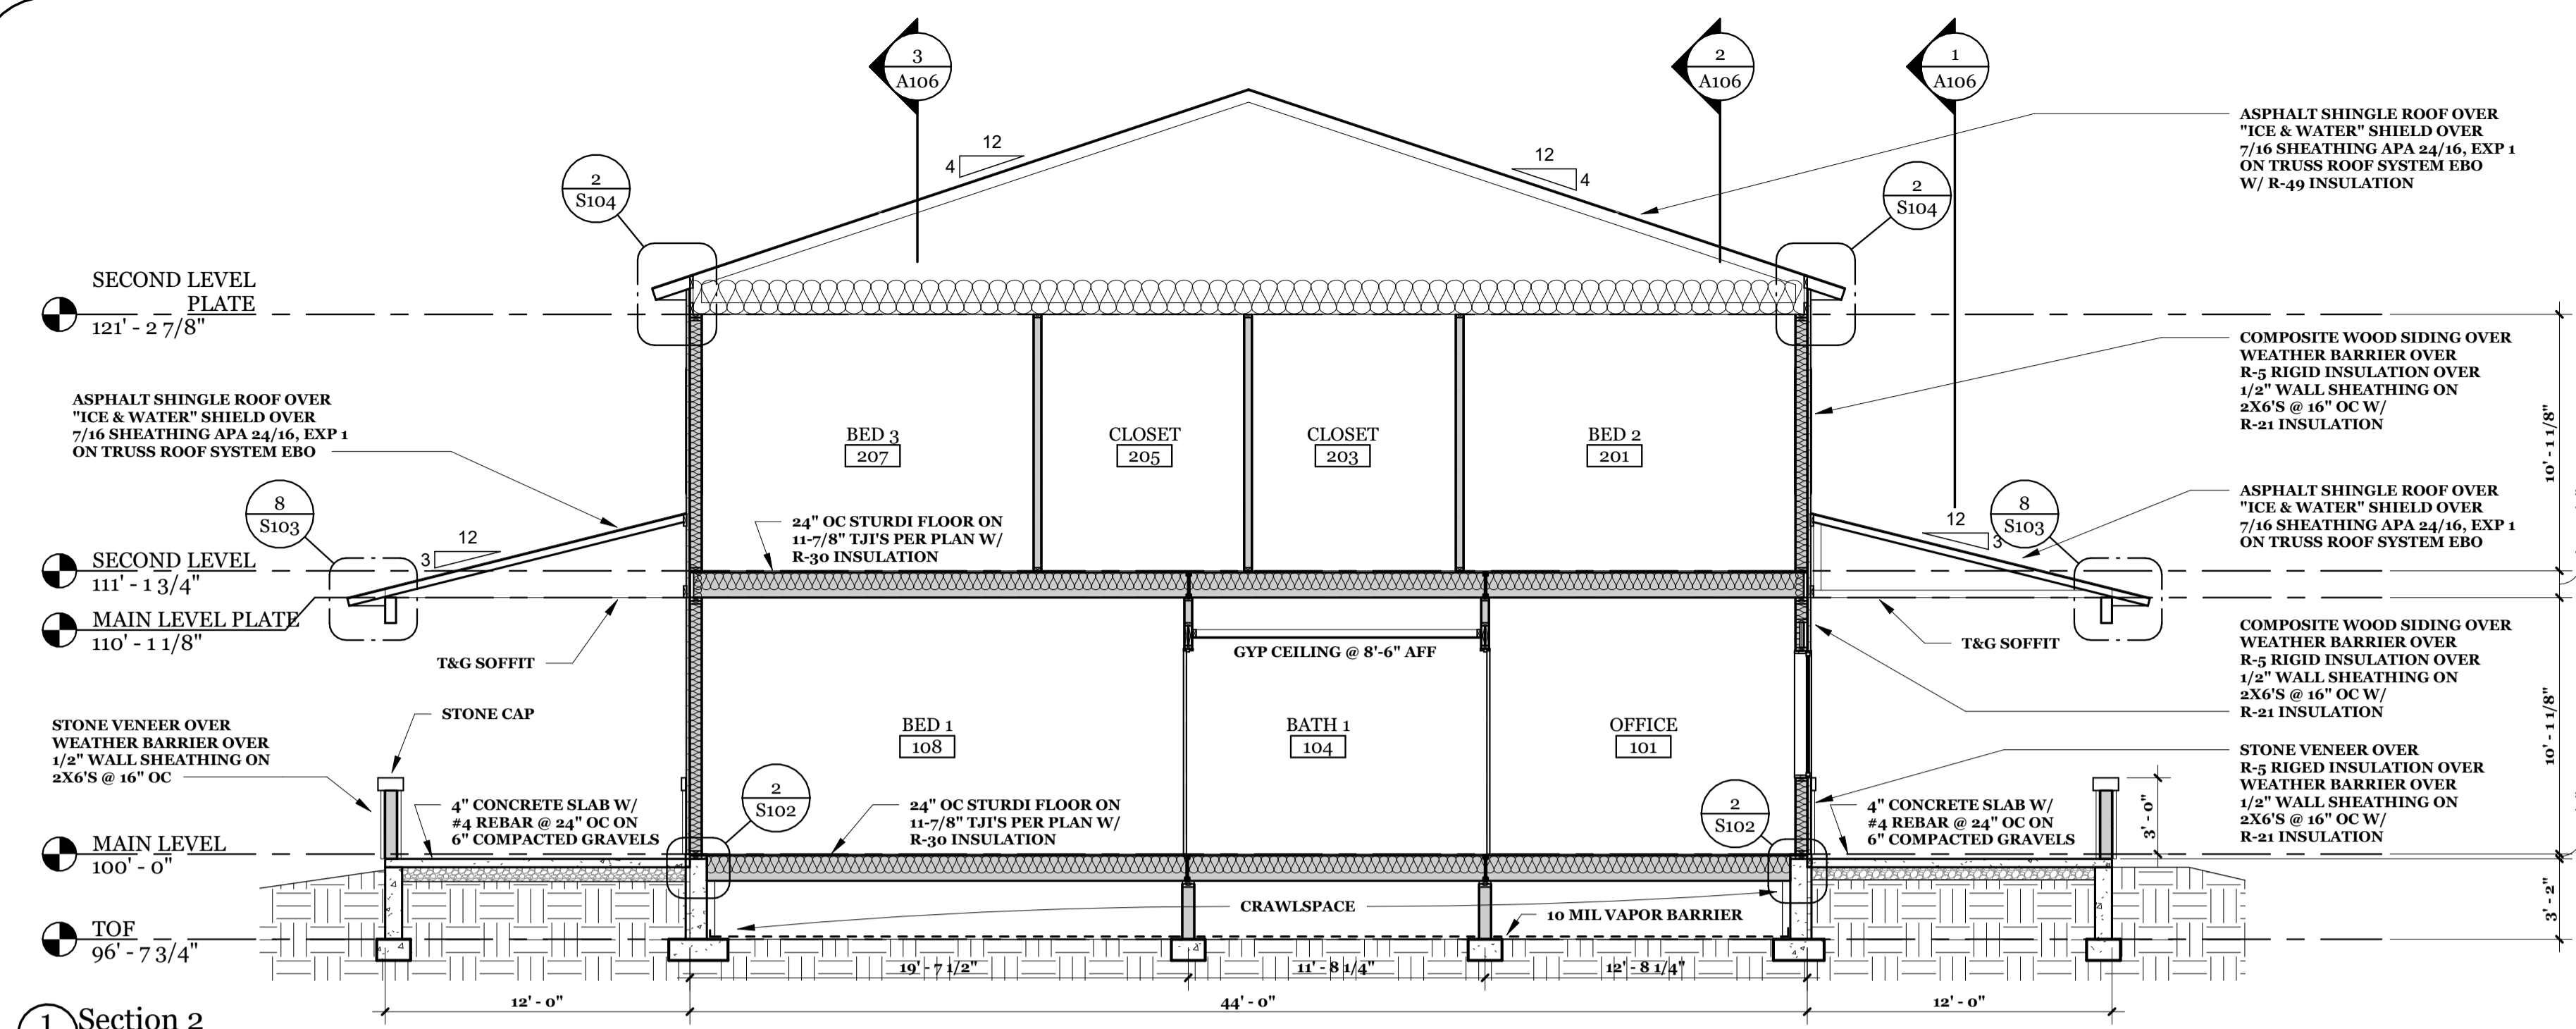

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 AND DESIGN


Professional Engineer
 WYLE A. BRIDGER
 17110
 Date 2022-11-16
 WYOMING
 "STRUCTURE ONLY"

BUILDING SECTIONS


GLOCK RESIDENCE
 30 GENEVA LN
 SHERIDAN, WY 82801
 OWNER/CONTRACTOR 480.239.6512

Job # 2022-22
 File 22.022
 Date 2022.10.24
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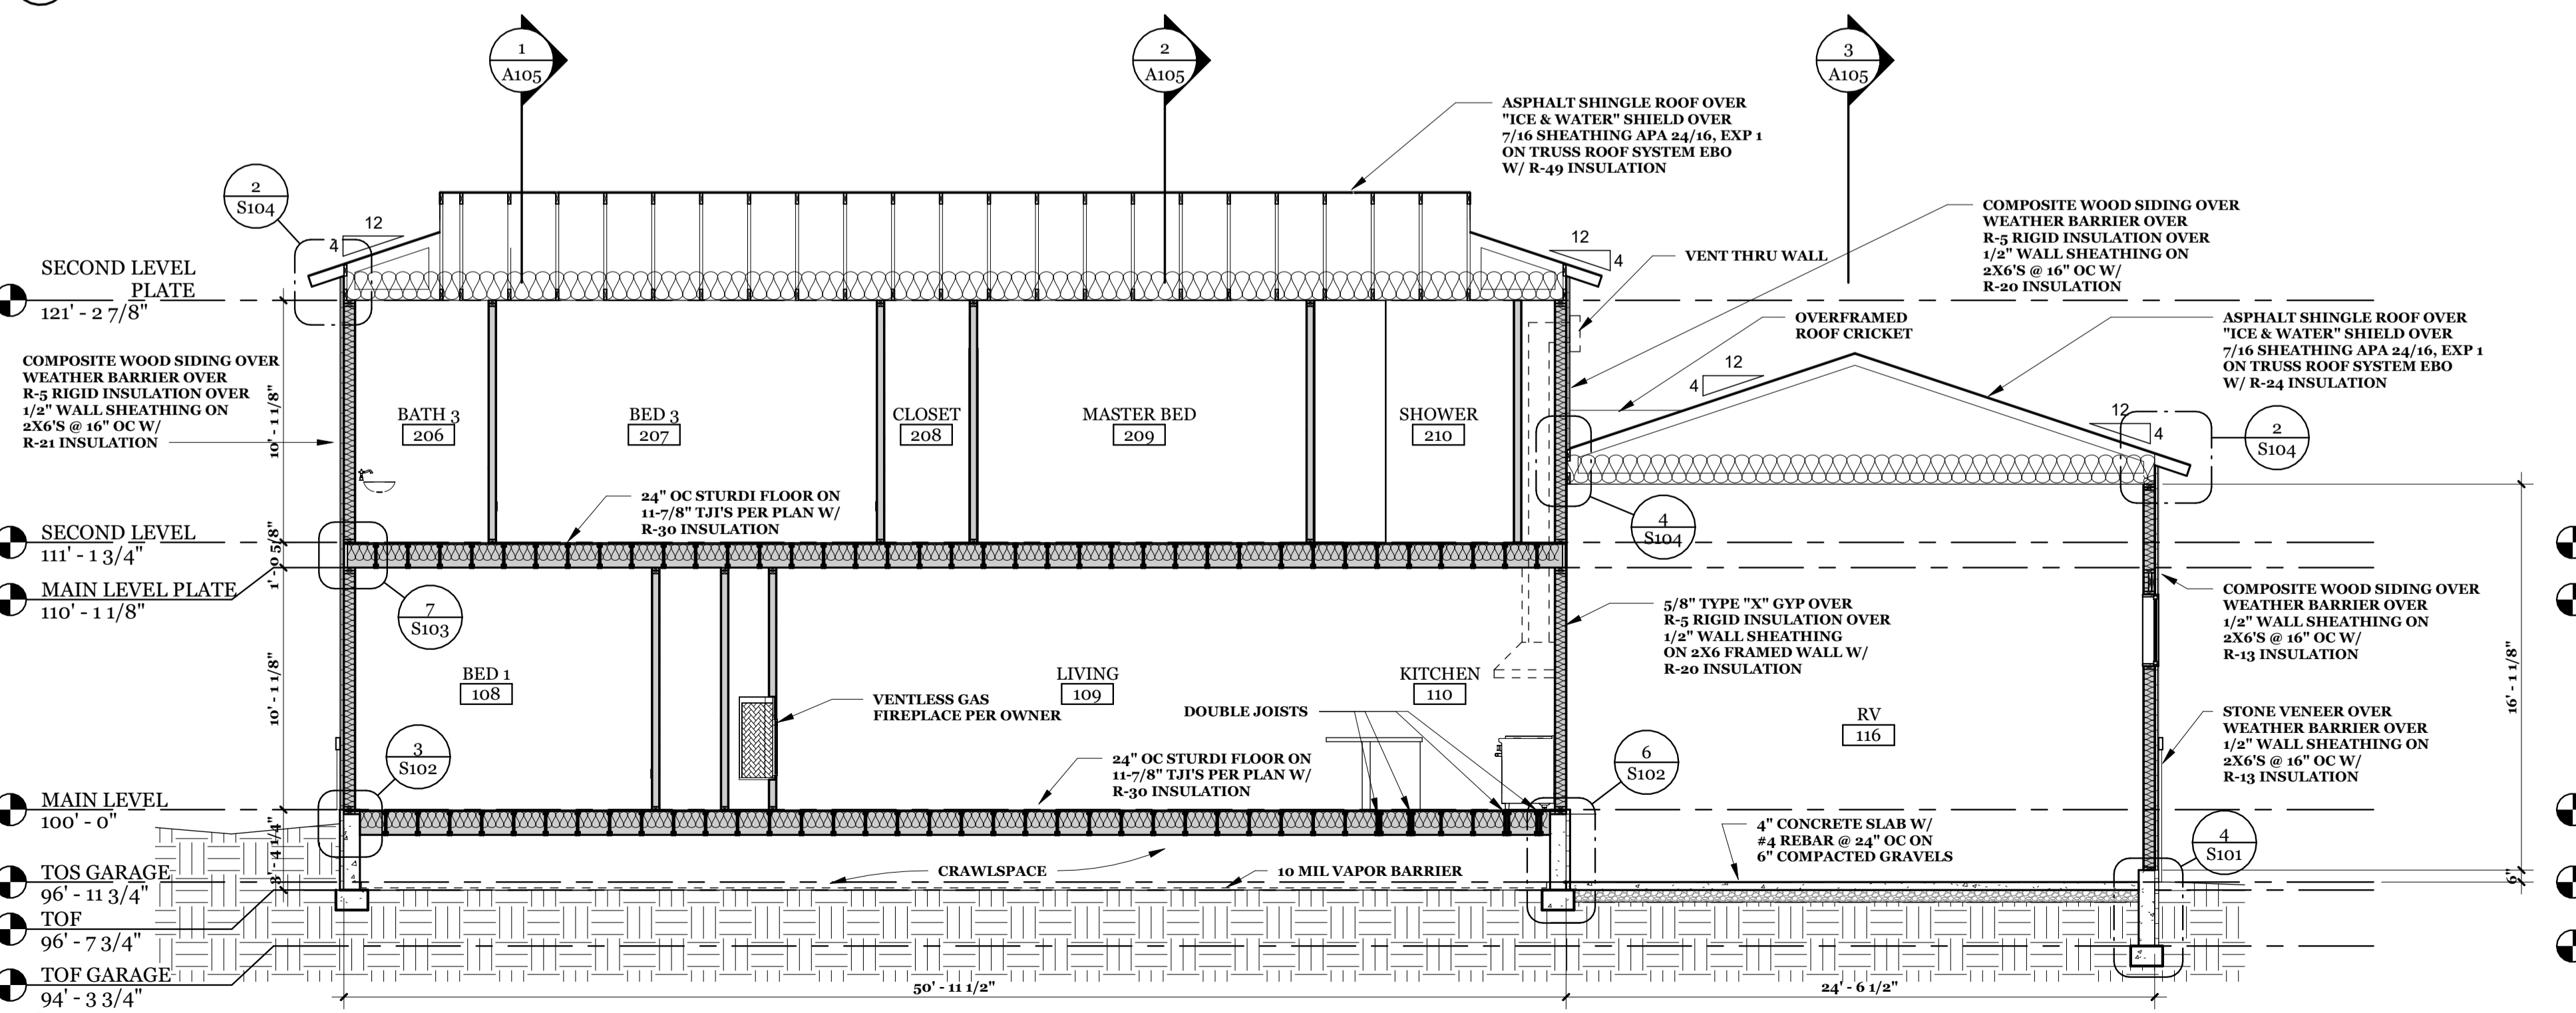
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A105
 SHEET 9 OF 14

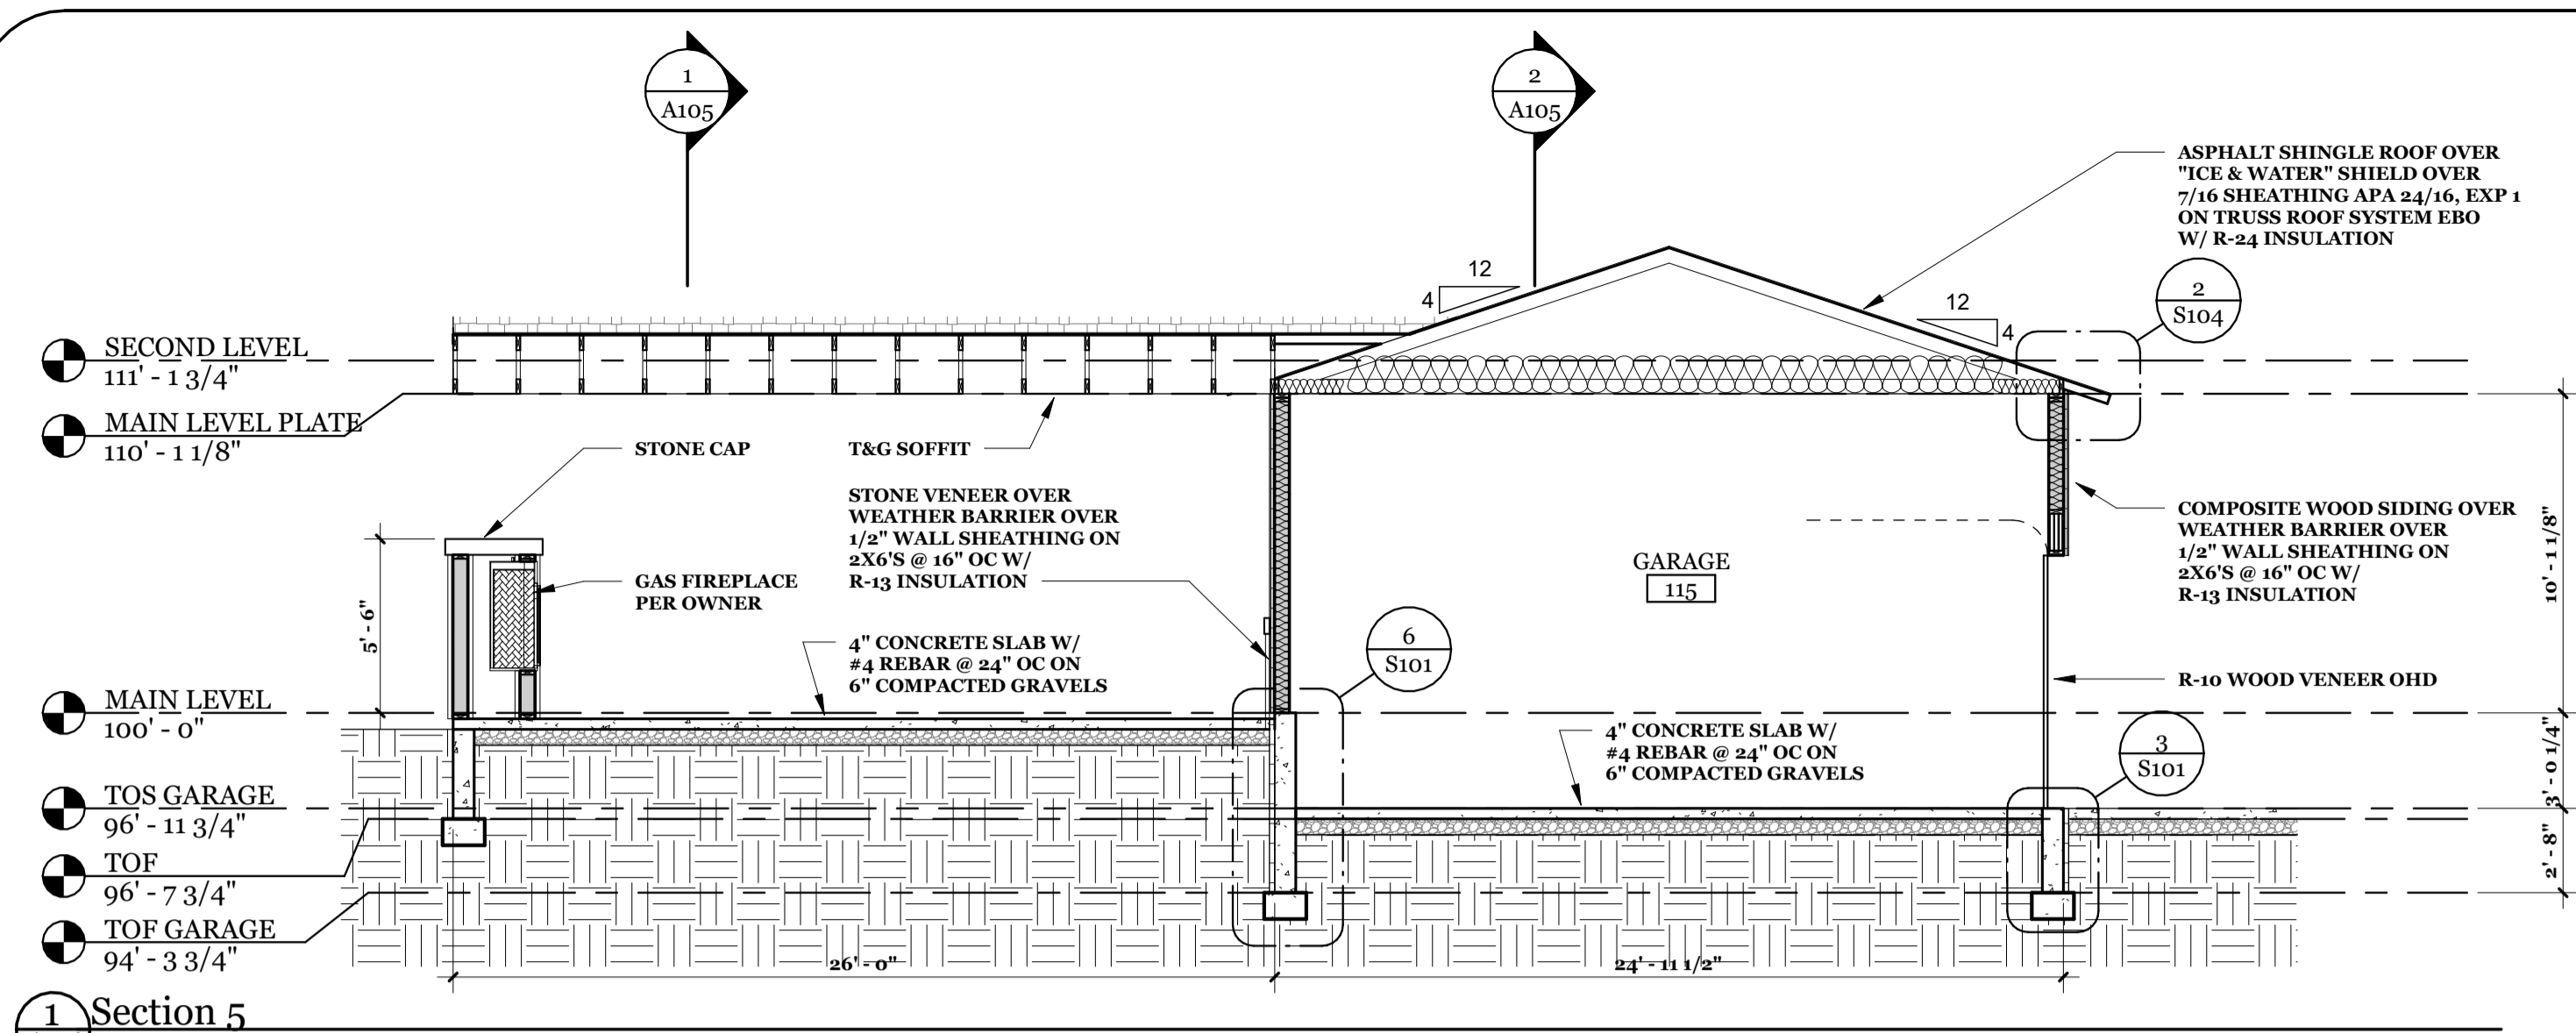


1 Section 5
A106 SCALE: 3/16" = 1'-0"

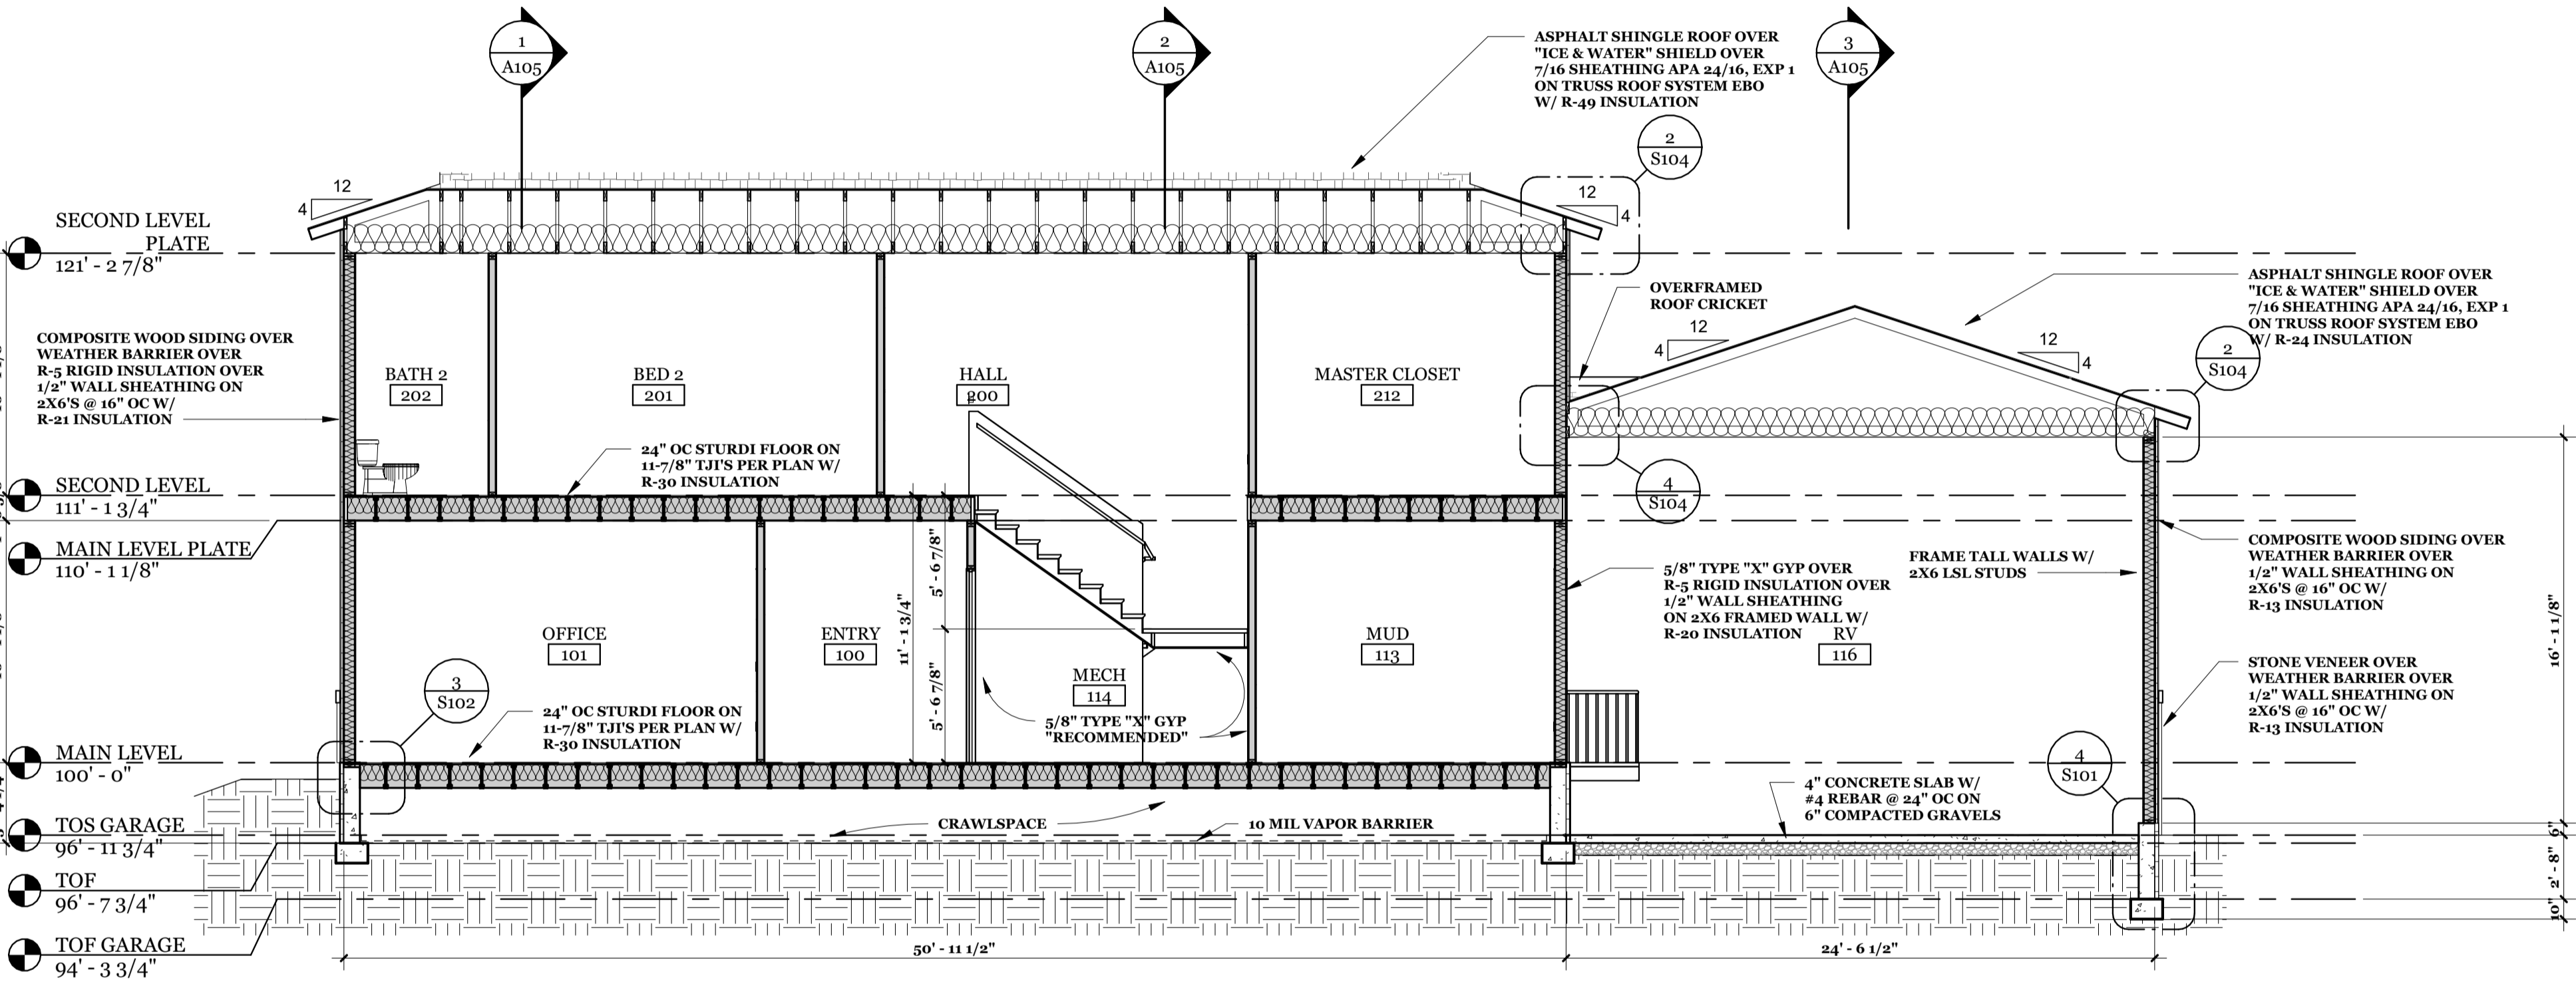

2 Section 6
A106 SCALE: 3/16" = 1'-0"




3 Section 7
A106 SCALE: 3/16" = 1'-0"

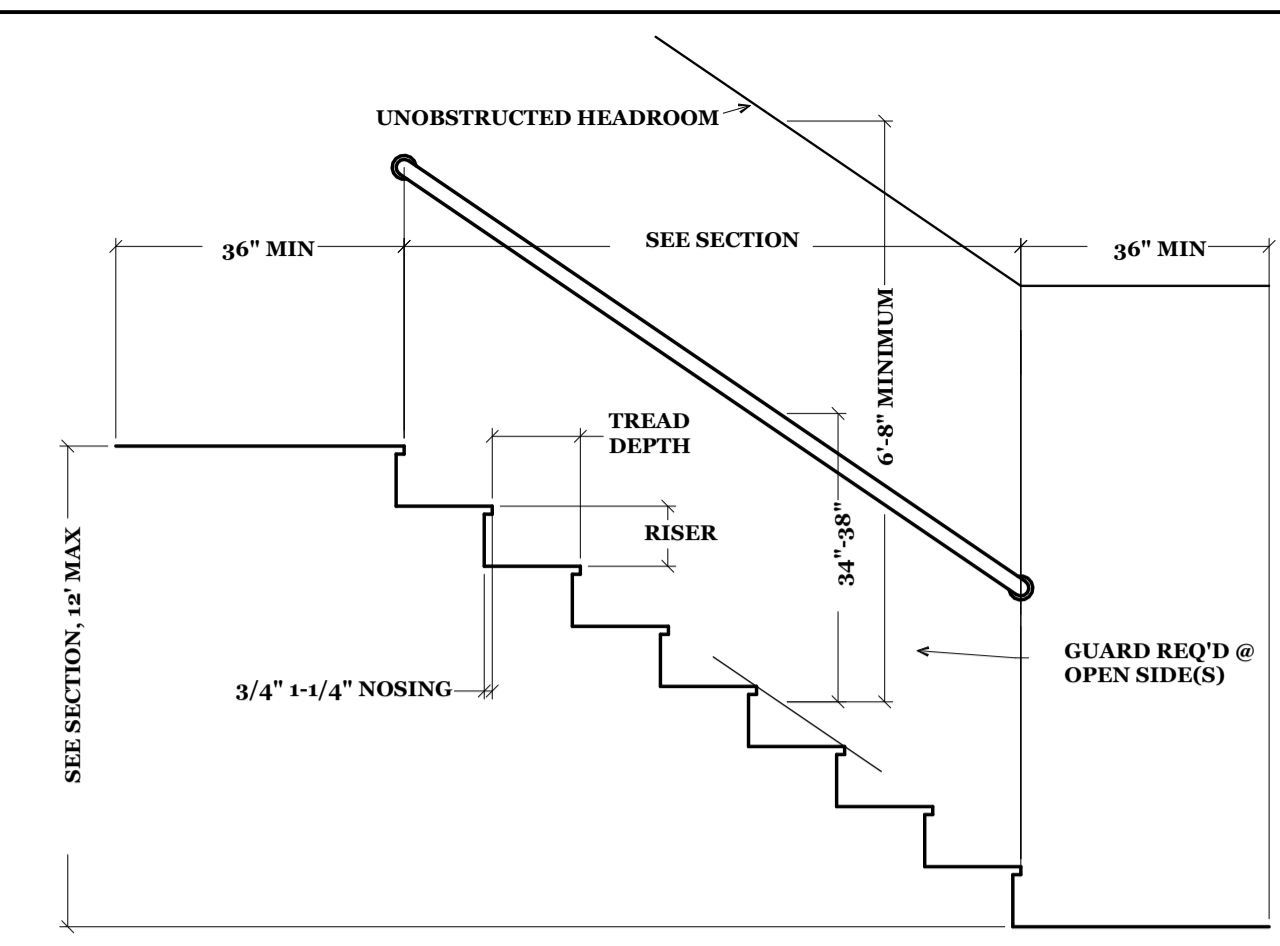


NOTES:
SEE IRC SECTION R312 FOR GUARD REQUIREMENTS AND SPECIFICATIONS
SEE IRC SECTION R311.7 FOR STAIRWAY REQUIREMENTS AND SPECIFICATIONS
SEE IRC SECTION R311.7.7 FOR HANDRAIL REQUIREMENTS AND SPECIFICATIONS
HANDRAIL SHALL BE RETURNED TO WALL OR TERMINATE @ NEWELL POST
MAXIMUM RISER OR TREAD DEPTH DEVIATION IS 3/8"
MAXIMUM RISER HEIGHT = 7-3/4", MINIMUM TREAD DEPTH = 10", UON
NOSING NOT REQUIRED WHEN TREAD DEPTH IS 11" MIN.

5 STAIR DETAIL
A106 SCALE: 1/2" = 1'-0"

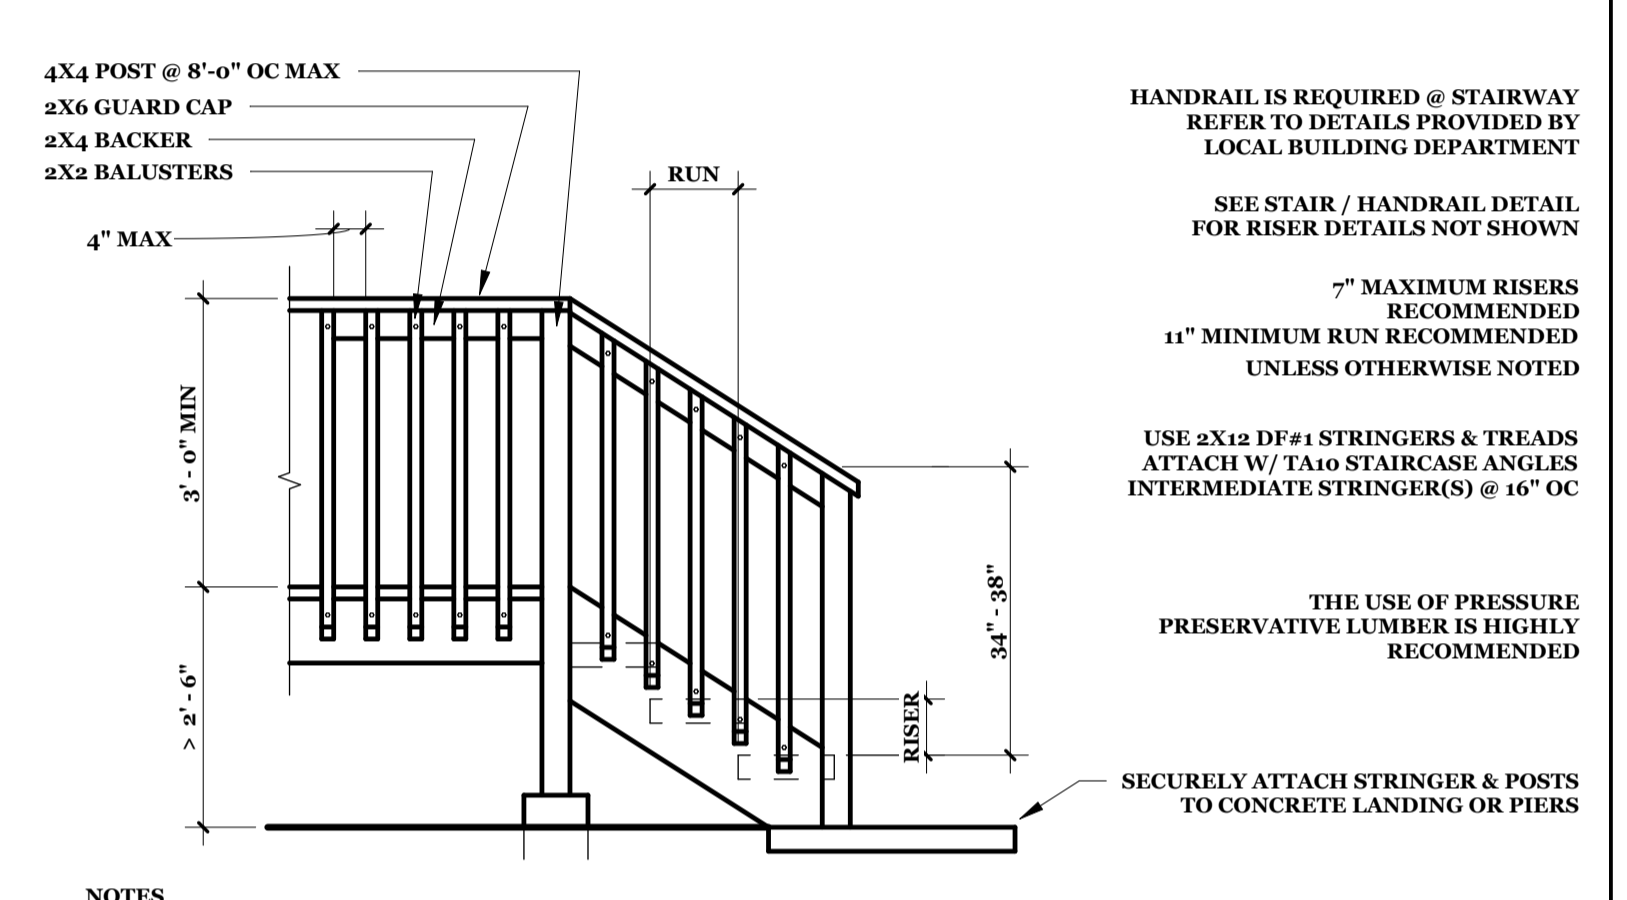

NOTES:
SEE SECTION R312 OF THE 2015 IRC FOR GUARD REQUIREMENTS AND SPECIFICATIONS
GUARDRAIL MUST NOT PASS A 4" SPHERE
GUARDRAIL REQUIRED WHEN DECK, PORCH OR BALCONY TO GRADE OR FLOOR BELOW EXCEEDS 30"
SEE IRC SECTION R311.7 FOR STAIR REQUIREMENTS AND SPECIFICATIONS
OPEN RISERS SHALL NOT PASS A 4" SPHERE
SEE IRC SECTION R311.7.8.3 FOR HANDRAIL REQUIREMENTS AND SPECIFICATIONS
DETAILS SHOWN ARE RECOMMENDED FOR EXTERIOR USE - OTHER DETAILS MAY BE ACCEPTABLE

6 GUARD / STAIR DETAIL 1
A106 SCALE: 1/2" = 1'-0"

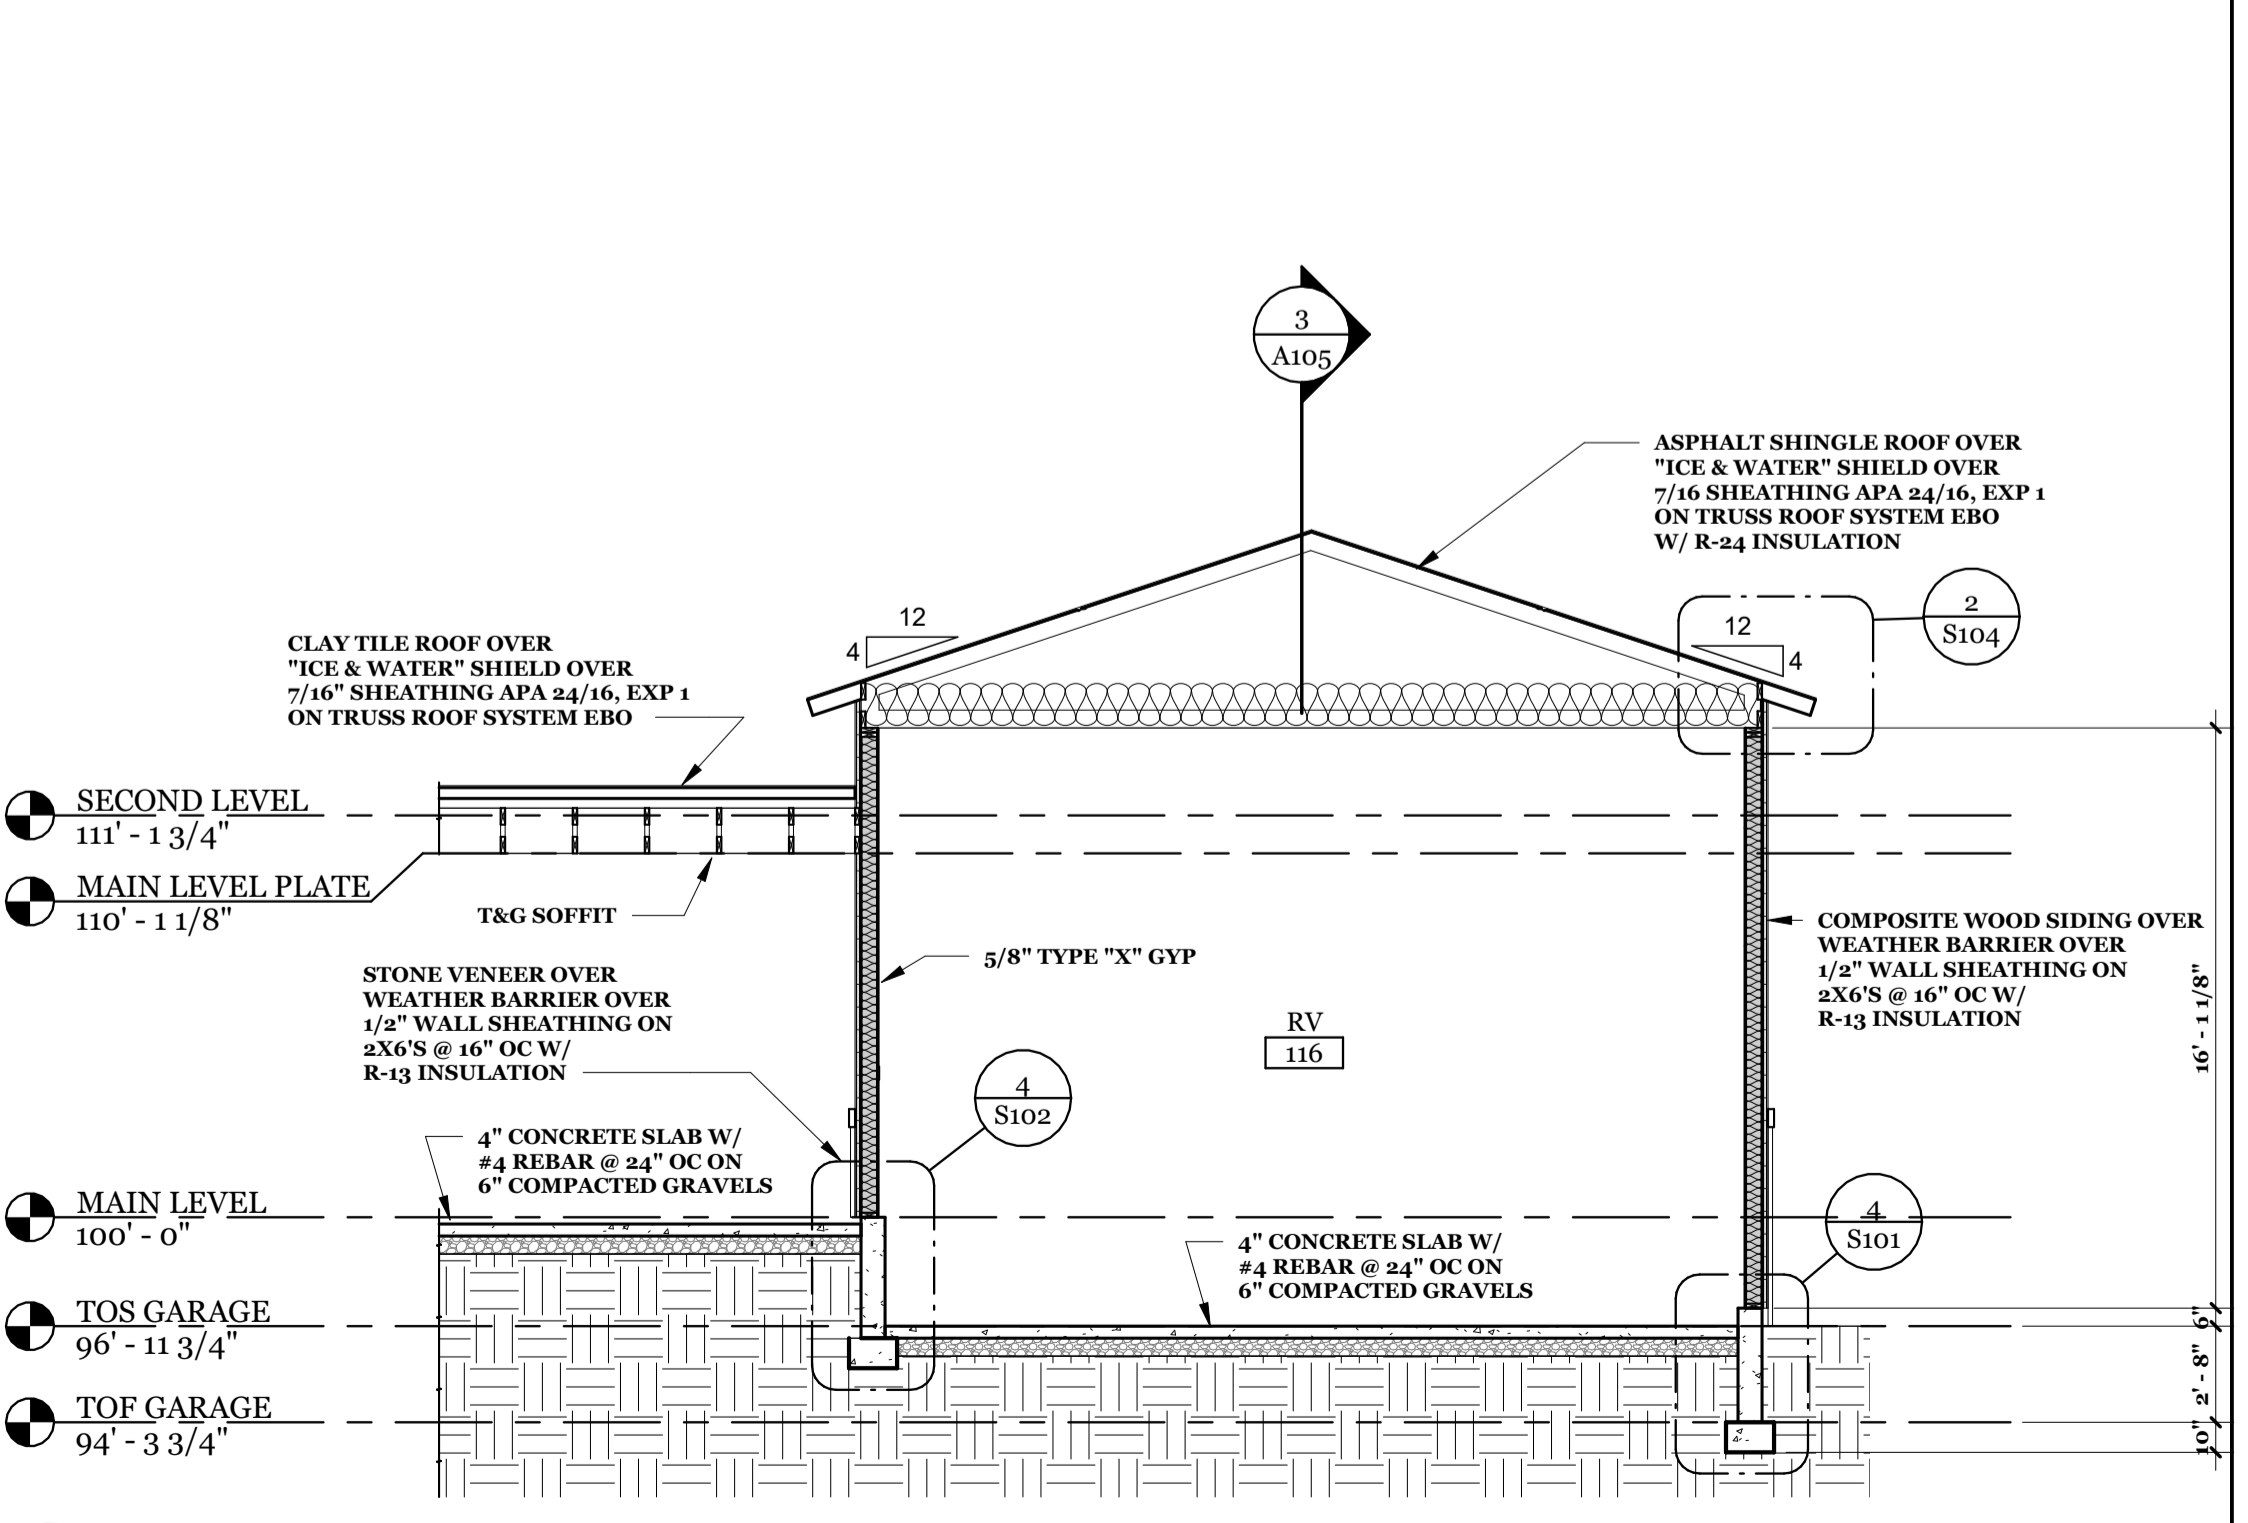

4 Section 8
A106 SCALE: 3/16" = 1'-0"

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BE

Professional Engineer
WYLE A. BRIDGER
17110
Date 2022-11-16
WYOMING
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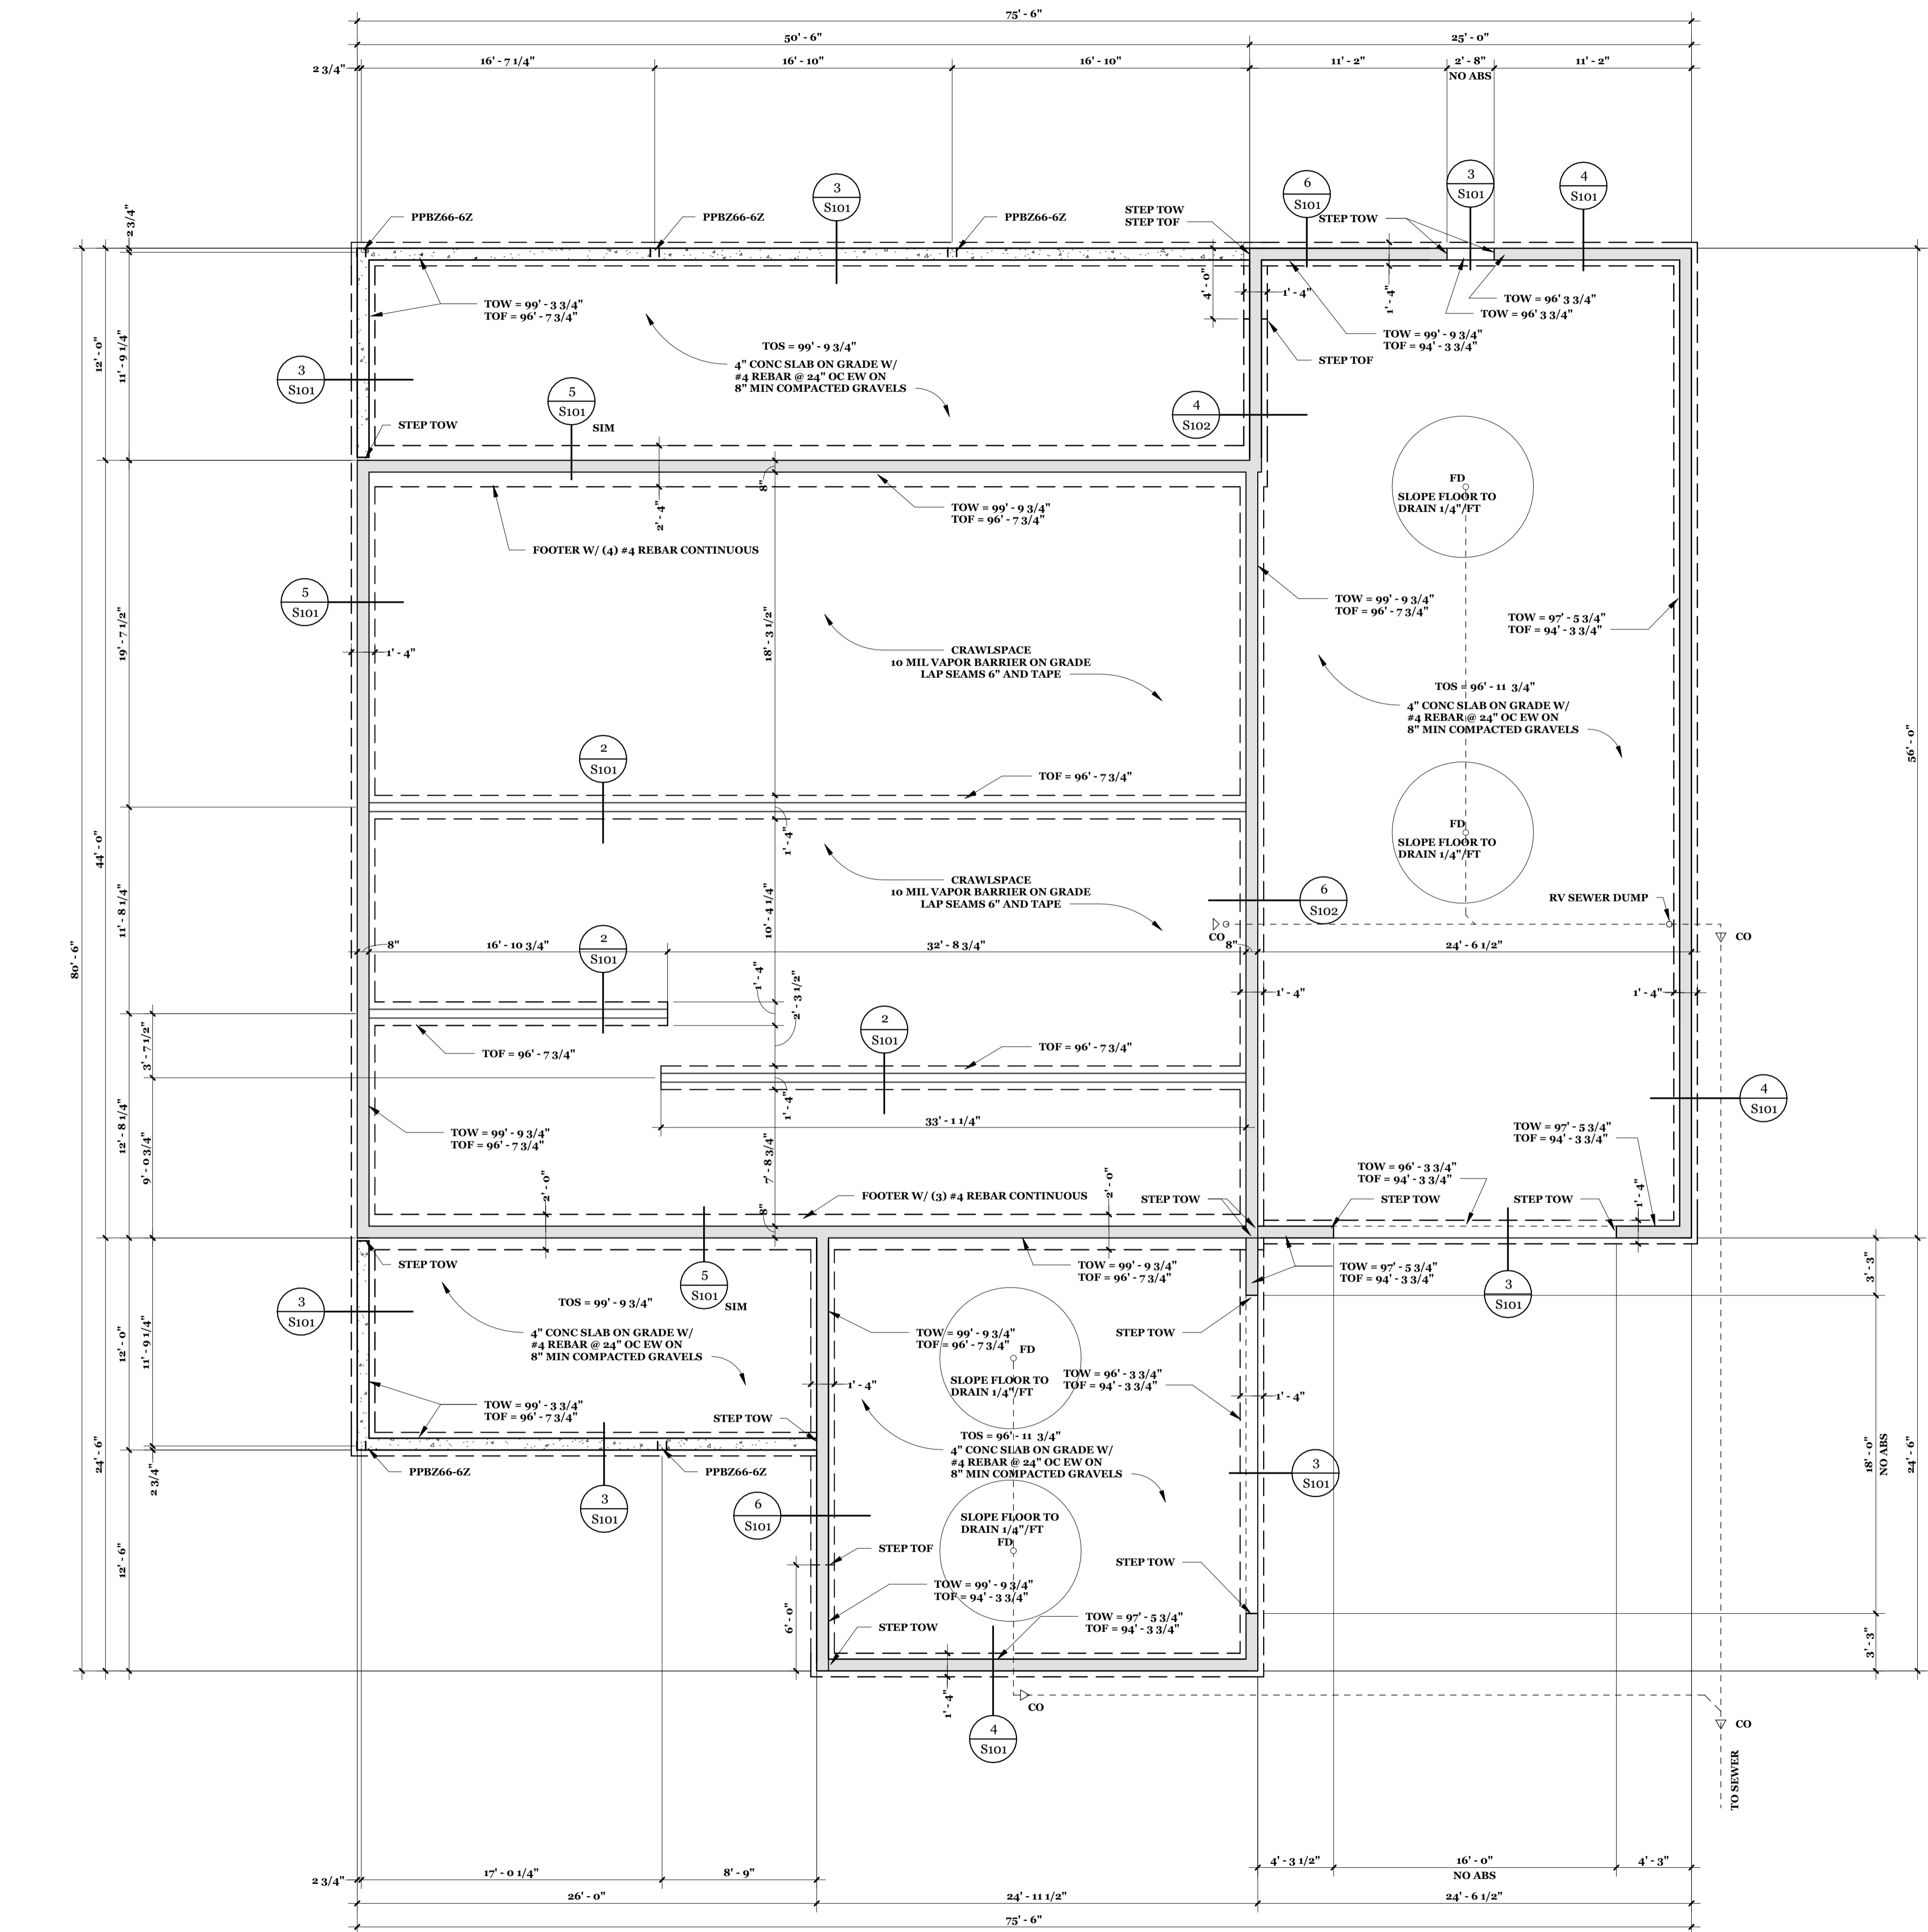
BUILDING SECTIONS

GLOCK RESIDENCE

30 GENEVA LN
SHERIDAN, WY 82801
OWNER/CONTRACTOR 480.239.6512


Job # 2022-22
File 22.022
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Rel'd 20-17-2022
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Sheet Number
A106
SHEET 10 OF 14




1 FOUNDATION PLAN
S101 SCALE: 3/16" = 1'-0"


NOTE:
COORDINATE ALL SUB SLAB PENETRATIONS
PROVIDE CRAWLSPACE VENTILATION SYSTEM SPER R408.3

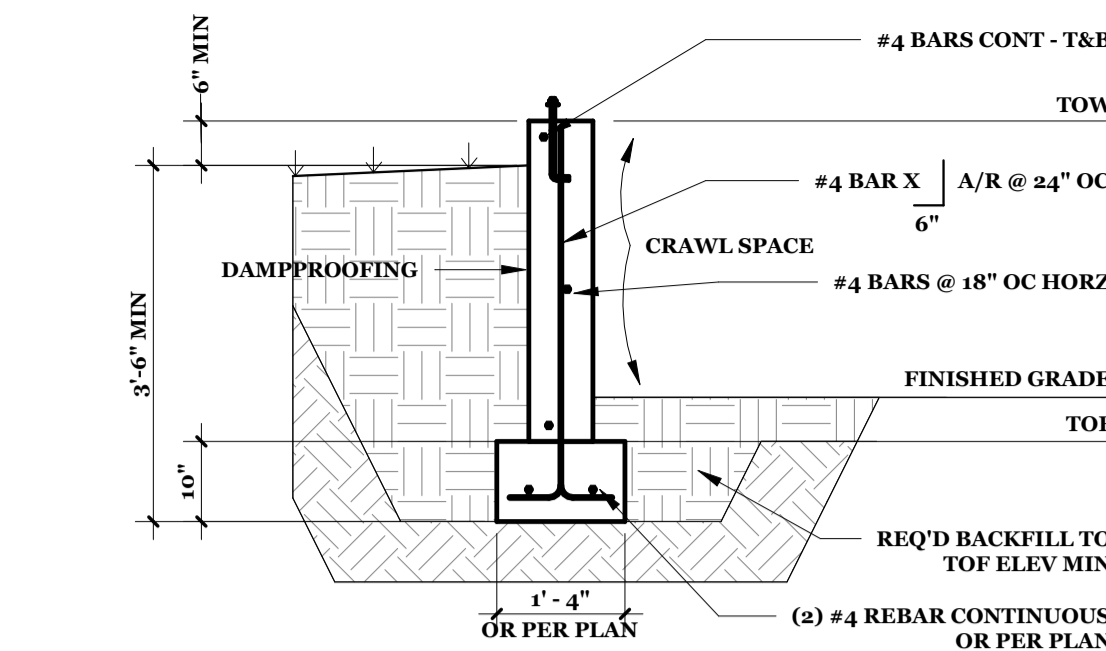


5 CRAWL SPACE WALL
S101 SCALE: 1/2" = 1'-0"

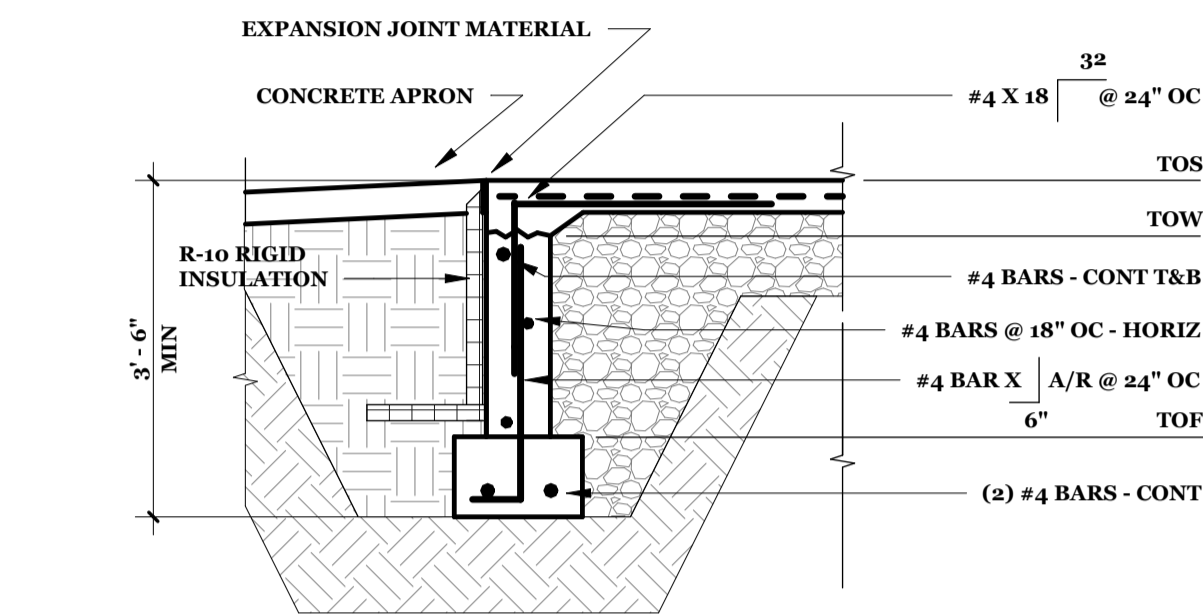


3 POUR OVER WALL
S101 SCALE: 1/2" = 1'-0"

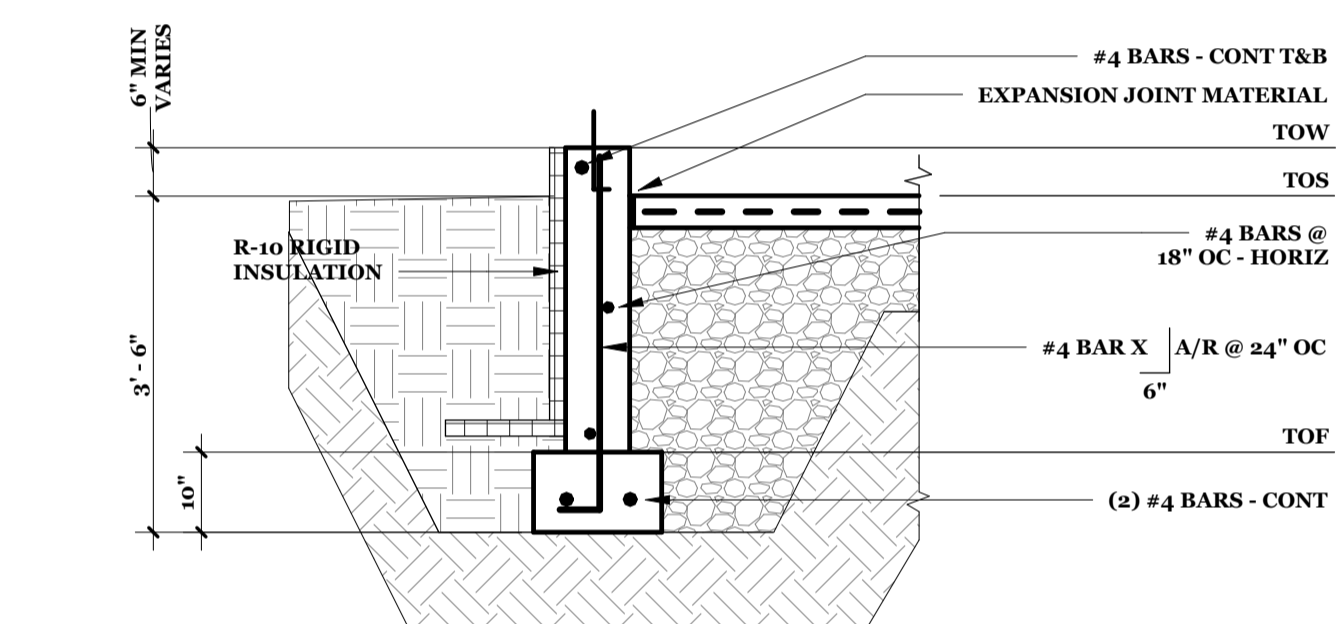


4 FROST WALL W/ SLAB
S101 SCALE: 1/2" = 1'-0"

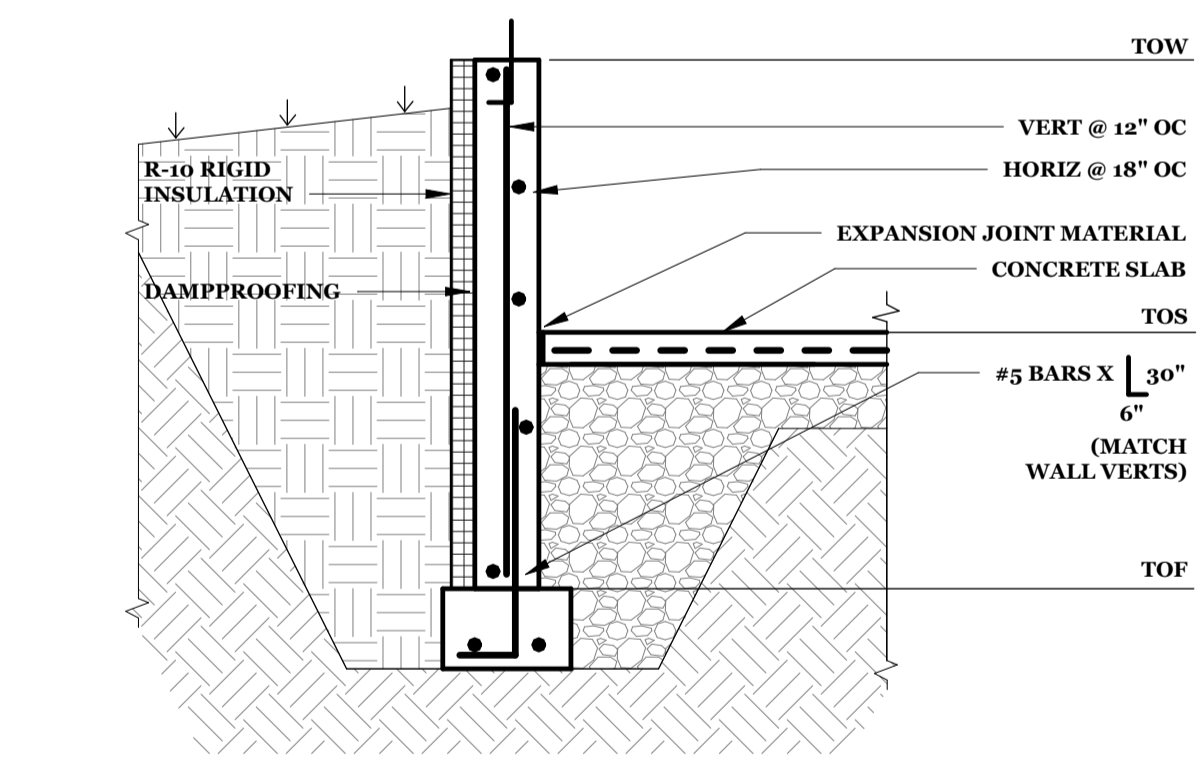

6 TRANSITION WALL 1
S101 SCALE: 1/2" = 1'-0"

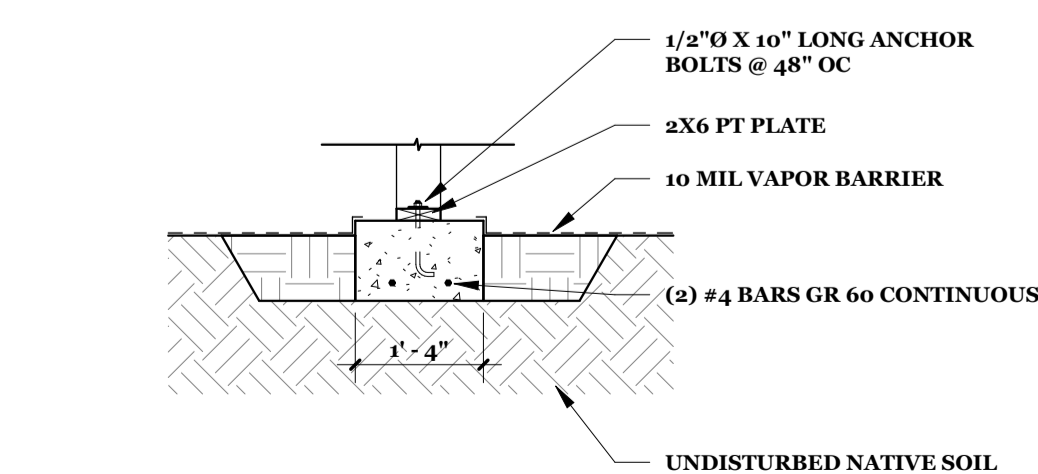


2 STRIP FOOTER DETAIL
S101 SCALE: 1/2" = 1'-0"

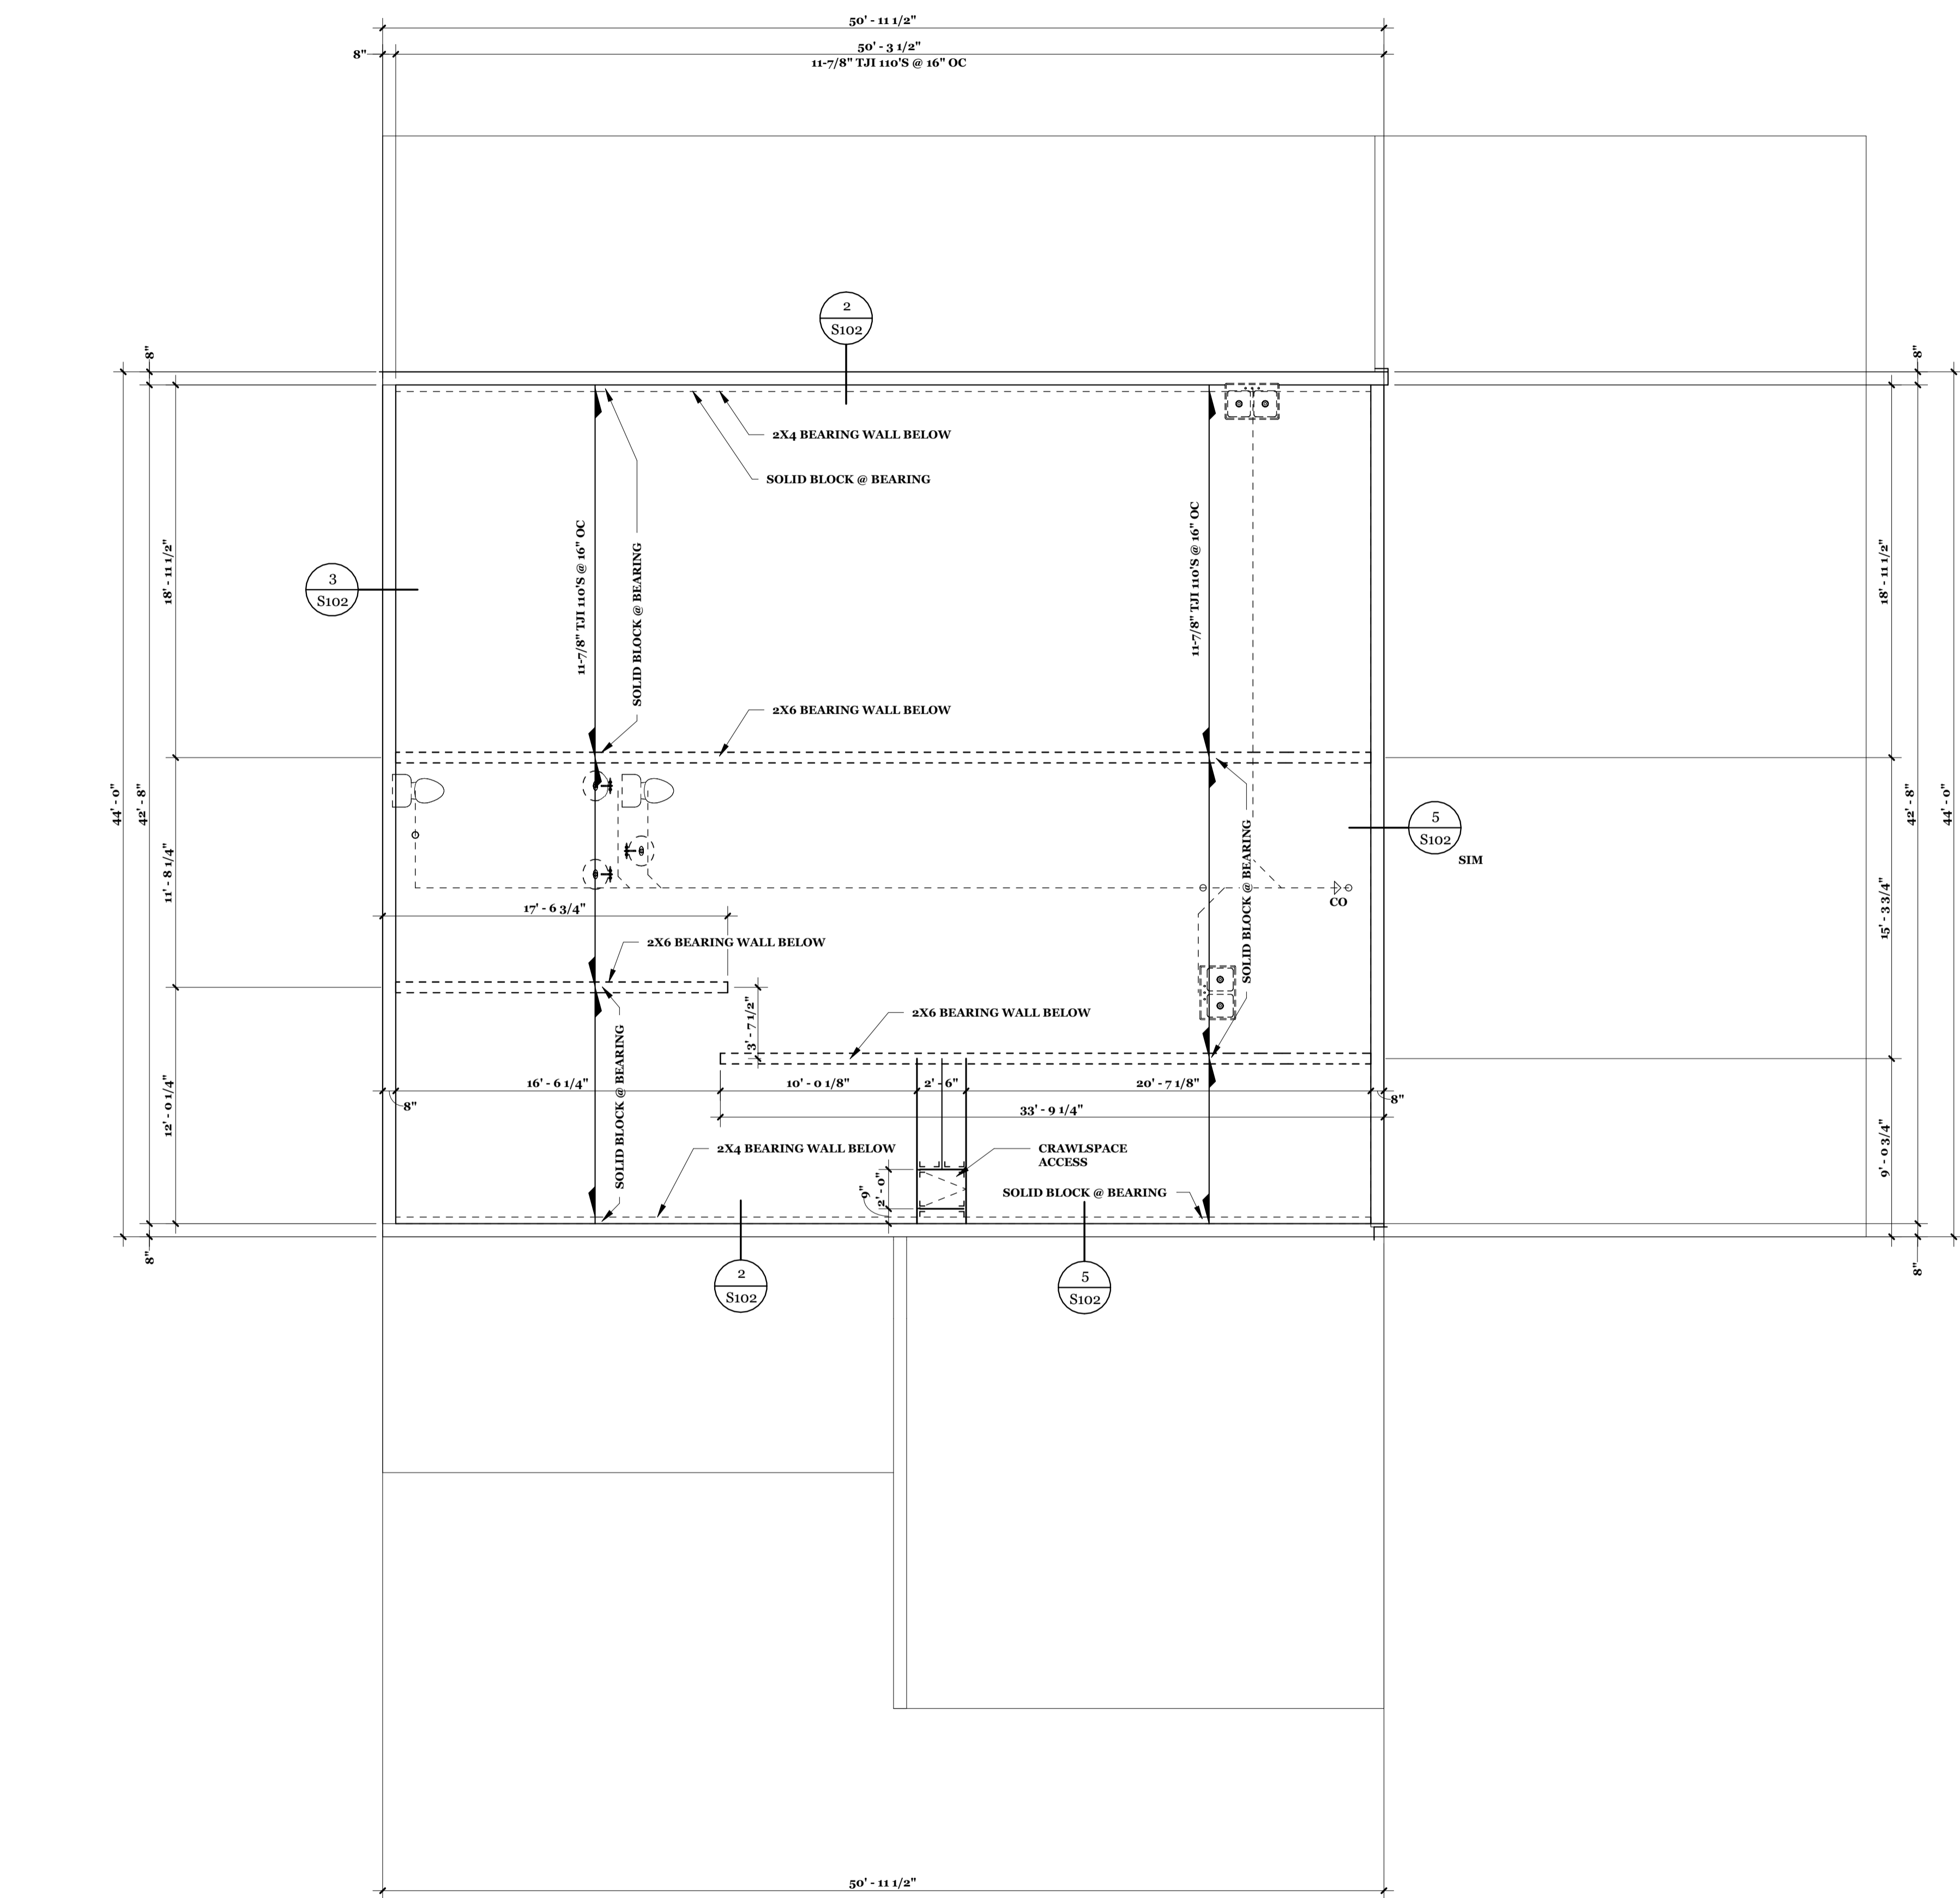


1 MAIN LEVEL FLOOR FRAMING PLAN
S102 SCALE: 3/16\" = 1'-0"

SHEATH FLOOR W/ 24\" OC STURDI FLOOR


2 FLOOR FRAMING DETAIL B
S102 SCALE: 1\" = 1'-0"

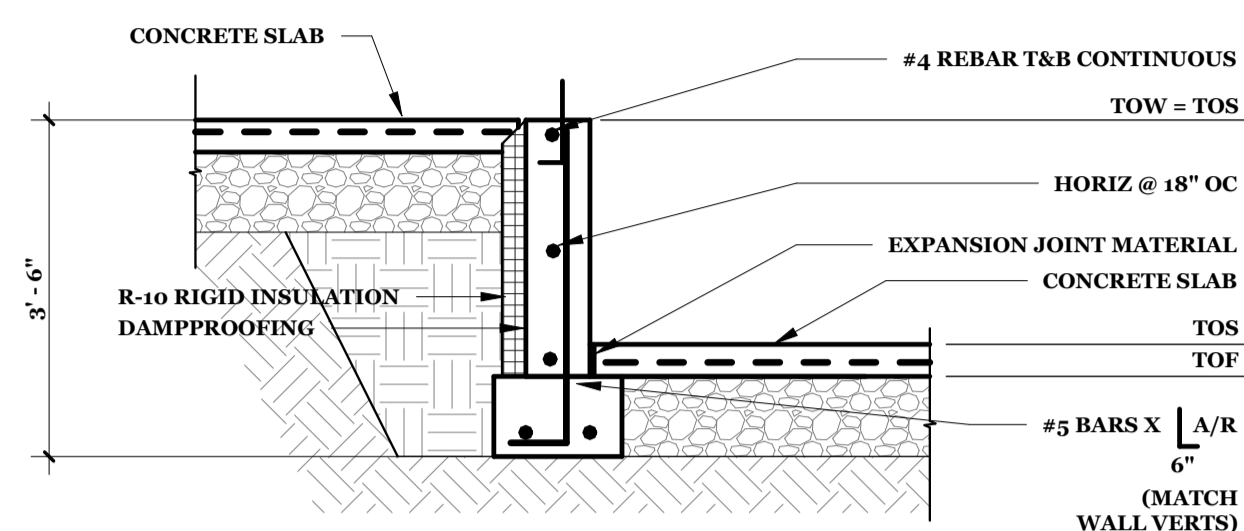


4 TRANSITION WALL 2
S102 SCALE: 1/2\" = 1'-0"

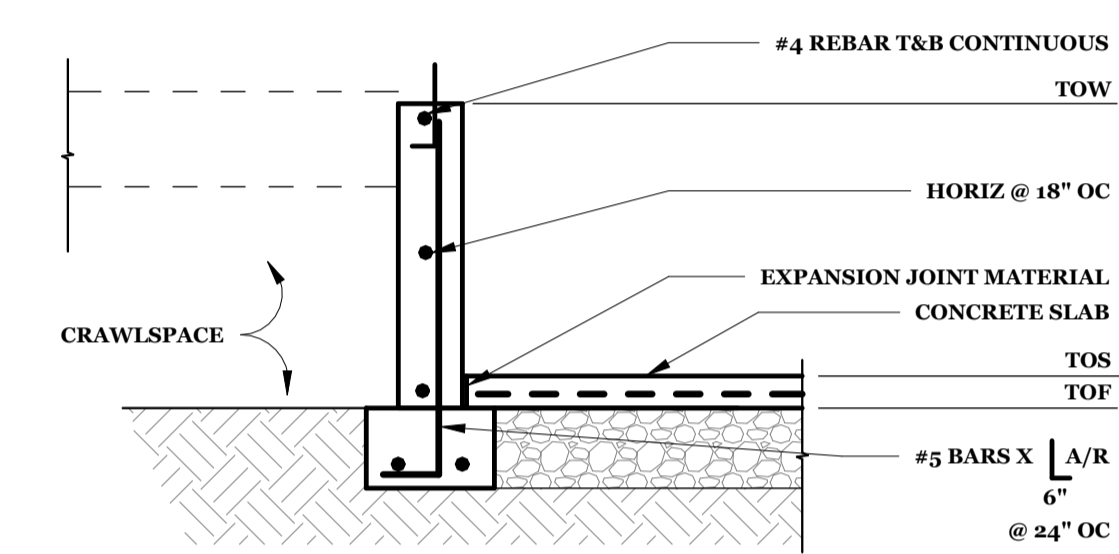


6 TRANSITION WALL 3
S102 SCALE: 1/2\" = 1'-0"

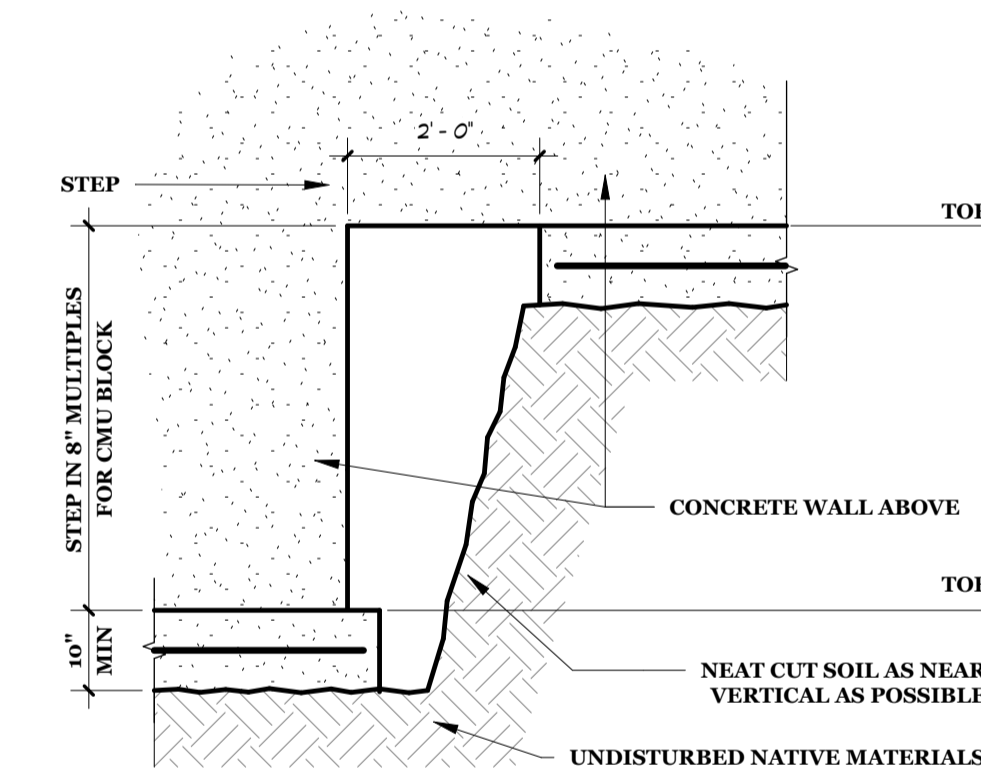


7 INTERRUPTED FOOTING
S102 SCALE: 1/2\" = 1'-0"

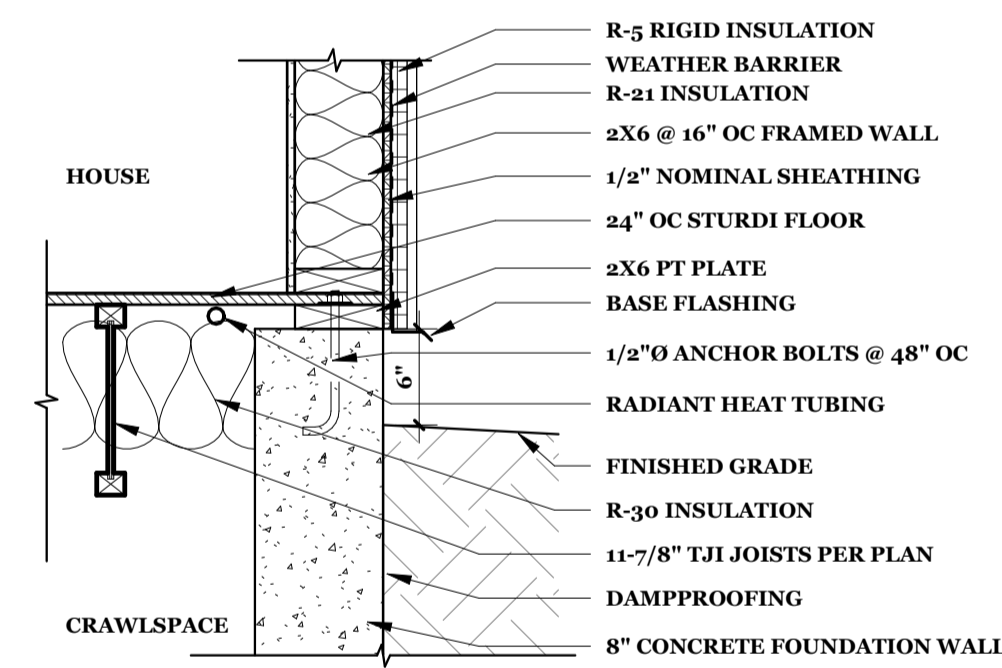

3 FLOOR FRAMING DETAIL A
S102 SCALE: 1\" = 1'-0"

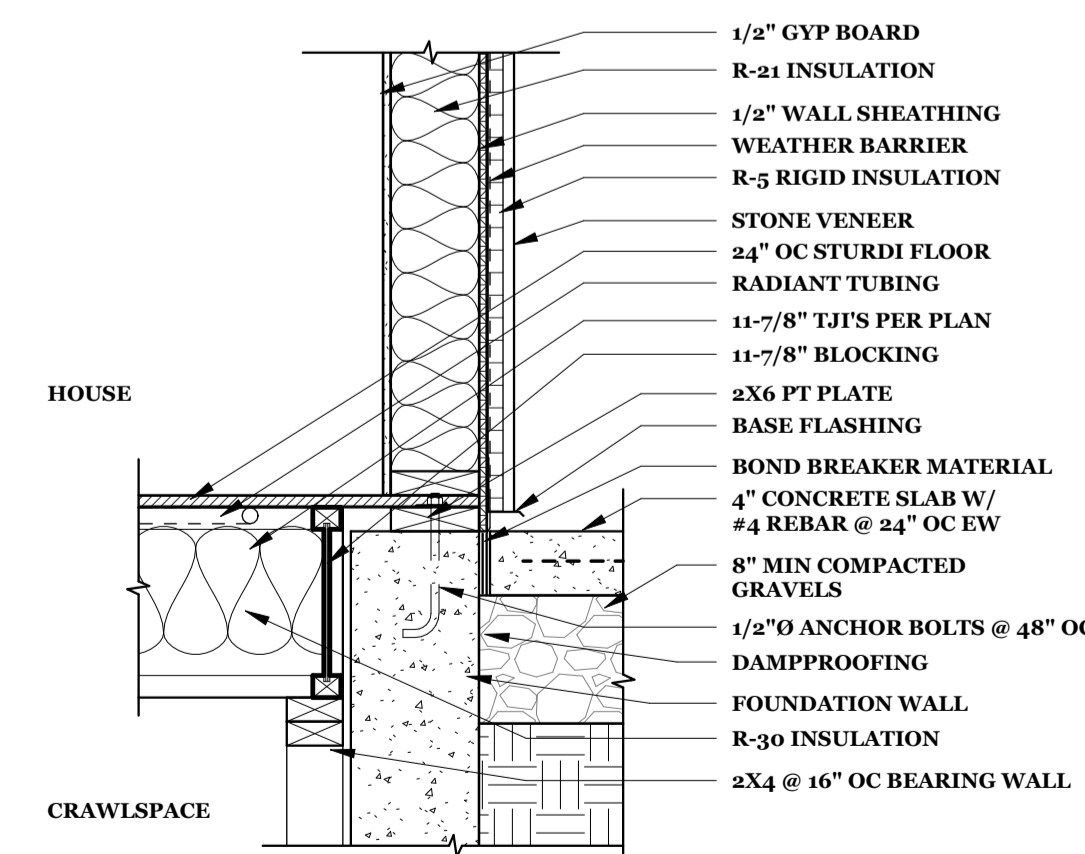

2 FLOOR FRAMING DETAIL B
S102 SCALE: 1\" = 1'-0"

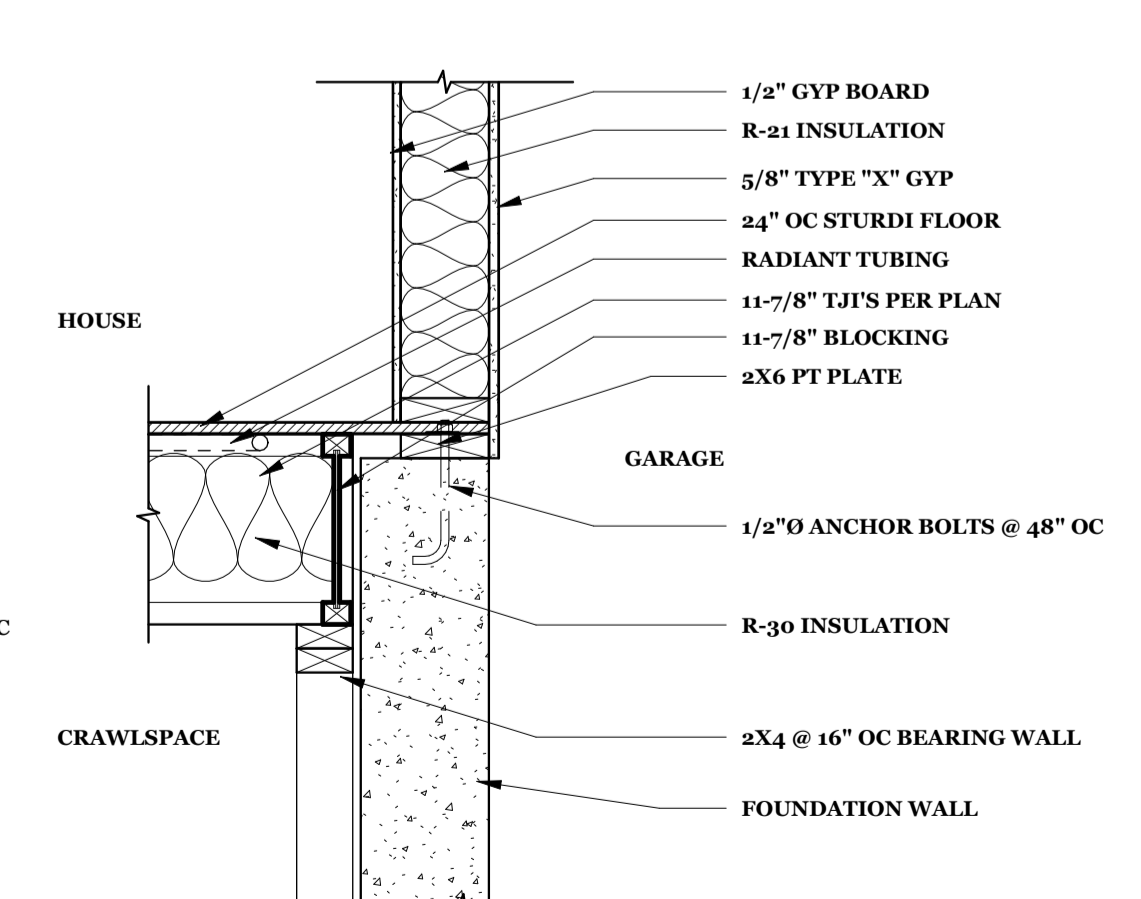

5 FLOOR FRAMING DETAIL C
S102 SCALE: 1\" = 1'-0"

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BE

Professional Engineer
KYLE A. BRIDGER
17110
Date 2022-11-16
WYOMING
"STRUCTURE ONLY"


MAIN LEVEL FLOOR FRAMING PLAN

GLOCK RESIDENCE
30 GENEVA LN
SHERIDAN, WY 82801
OWNER/CONTRACTOR 480.239.6512





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Sheet Number
S102
SHEET 12 OF 14

1 UPPER LEVEL FLOOR & LOWER ROOF FRAMING PLAN
S103 SCALE: 3/16" = 1'-0"

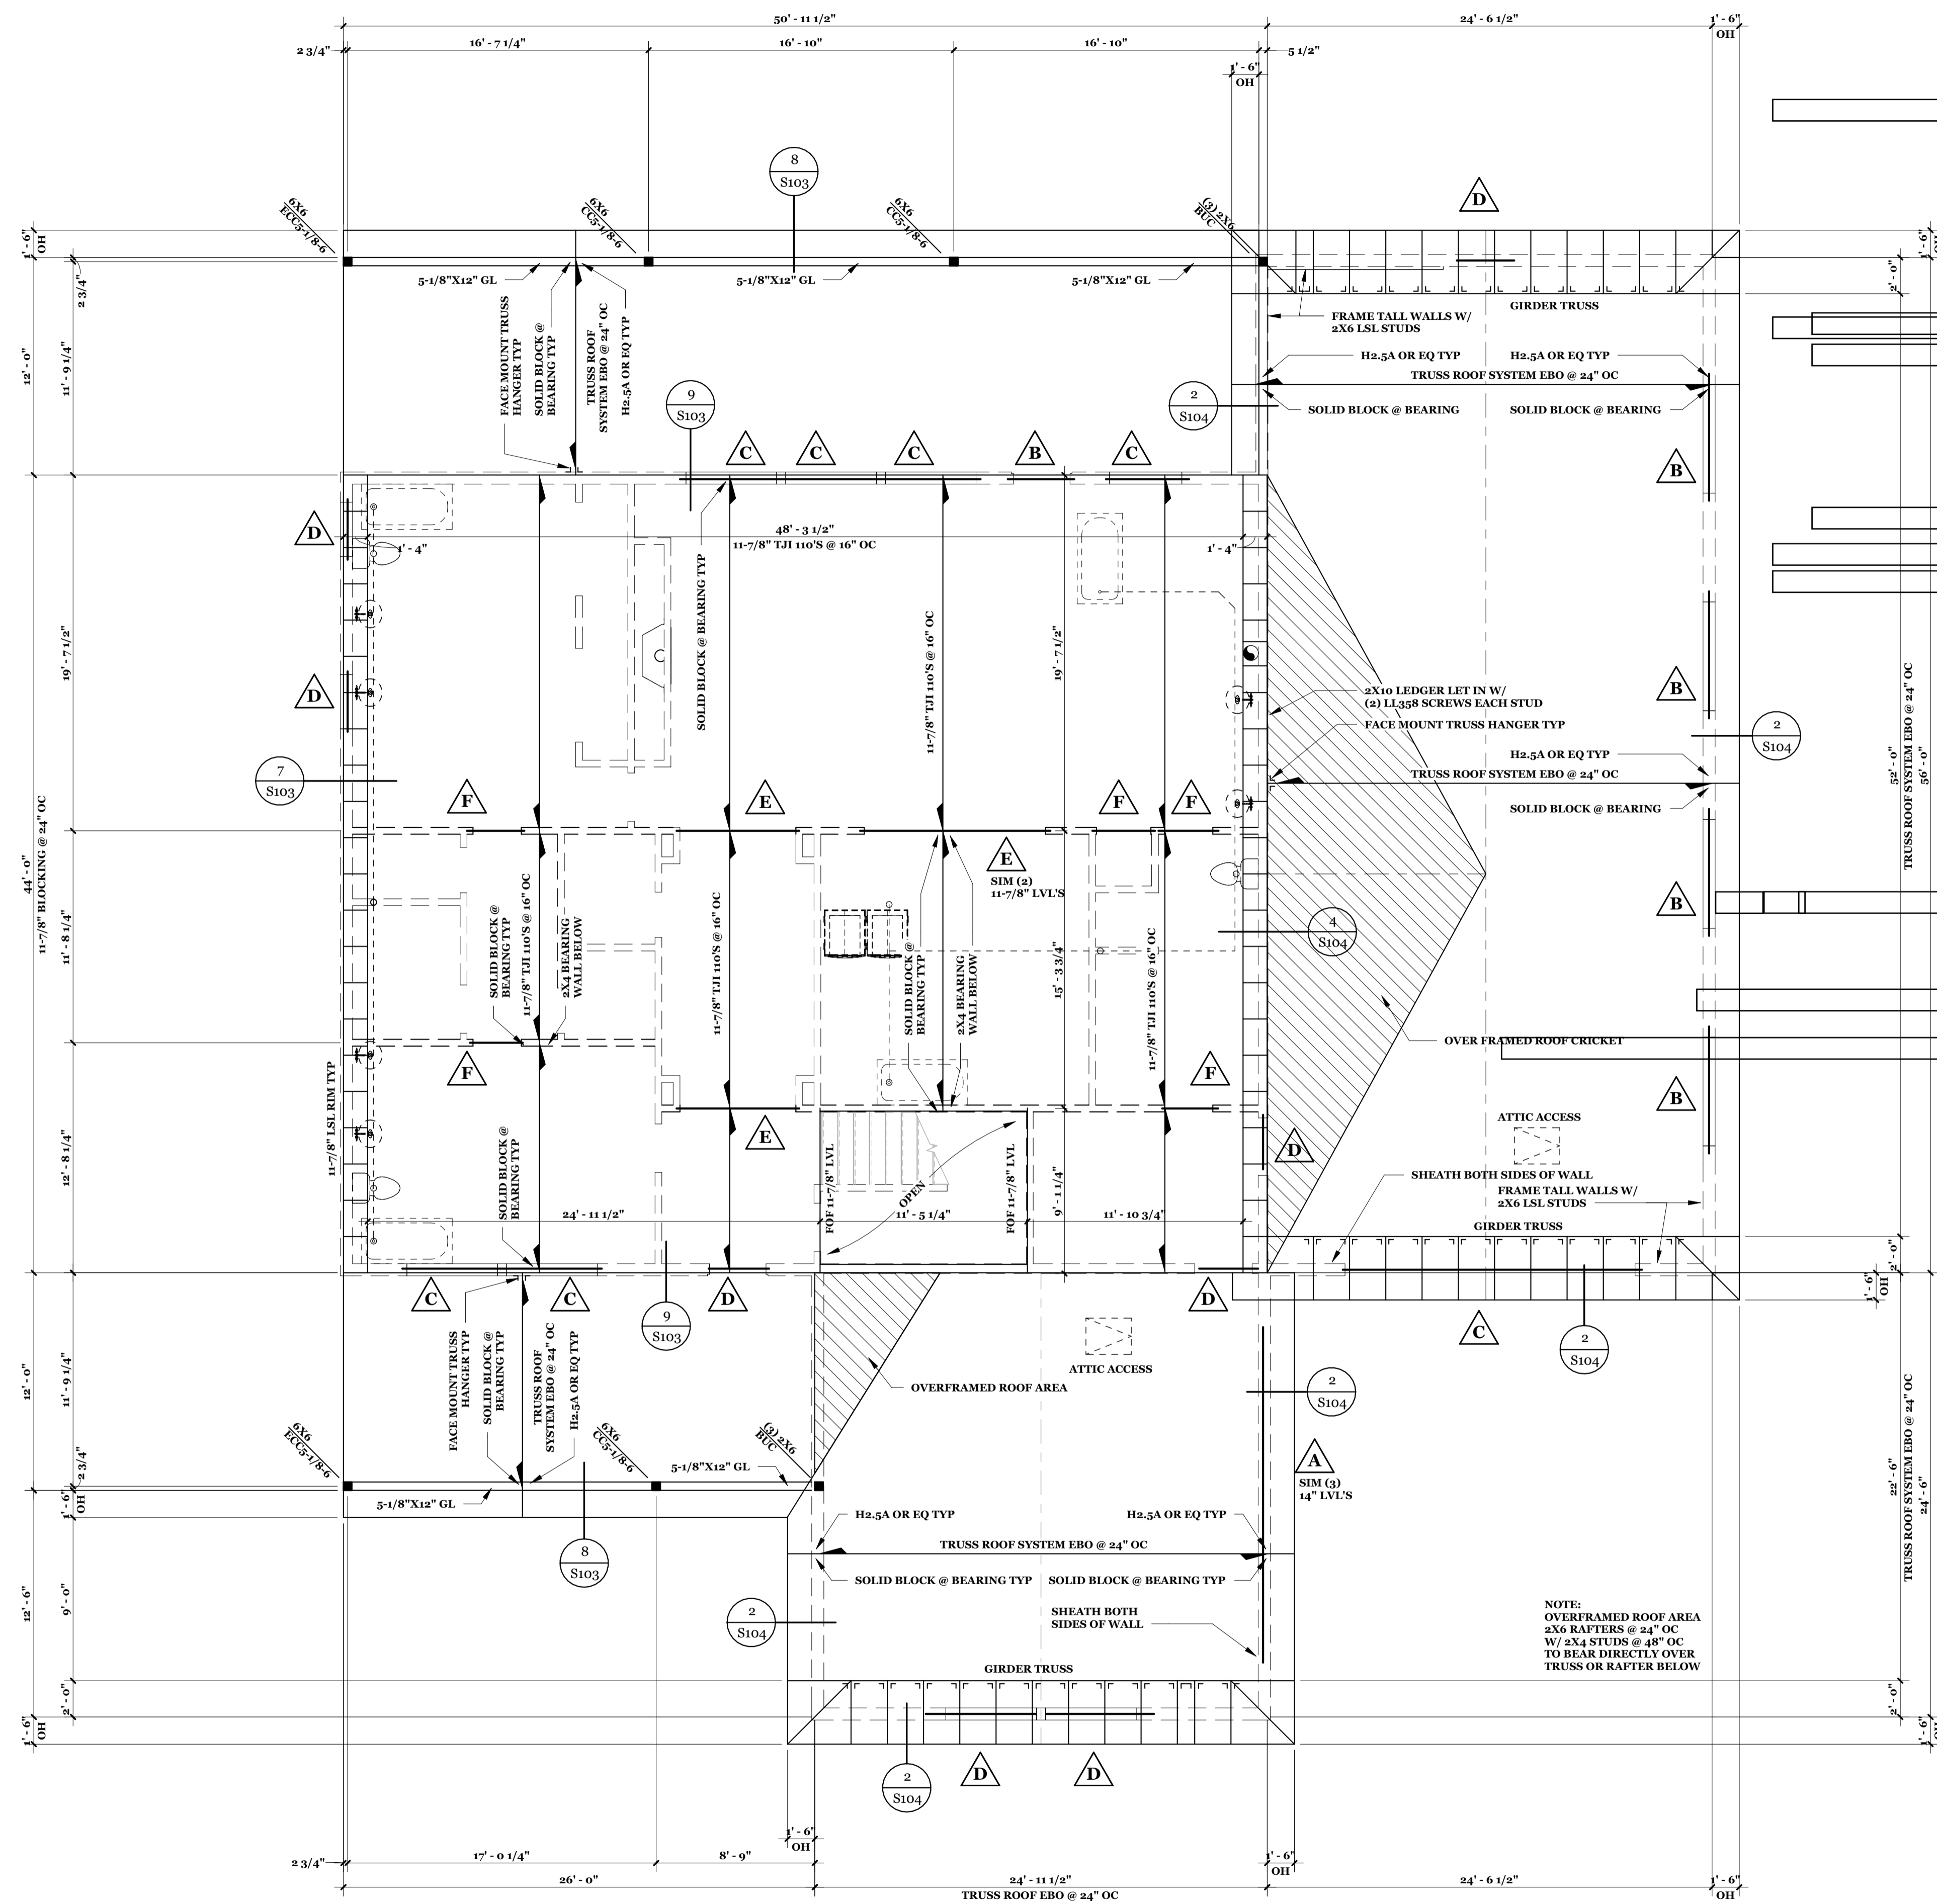

SHEATH ROOFS W/ 7/16" PLY APA 24/16 EXP 1
SHEATH FLOORS W/ 24" OC STURDI FLOOR
ALL UNLISTED HEADERS TO BE (2) 2X10'S

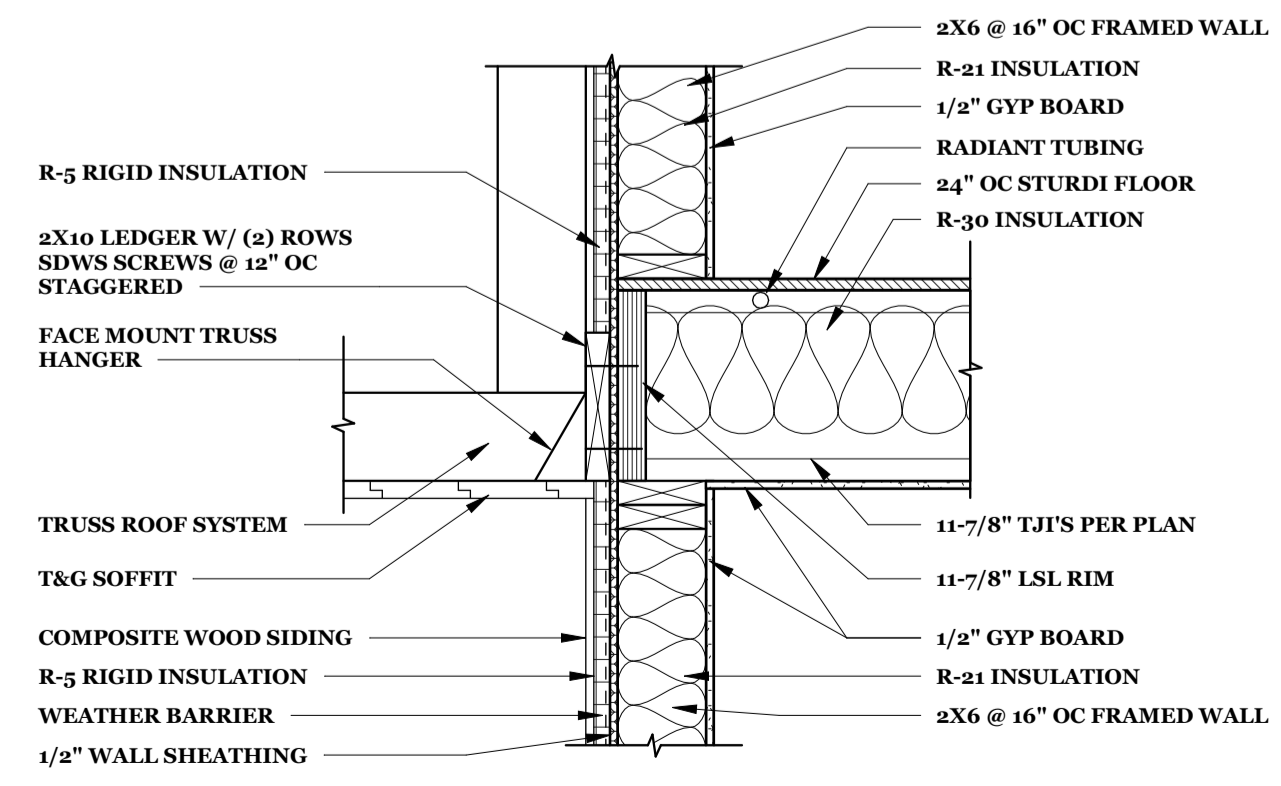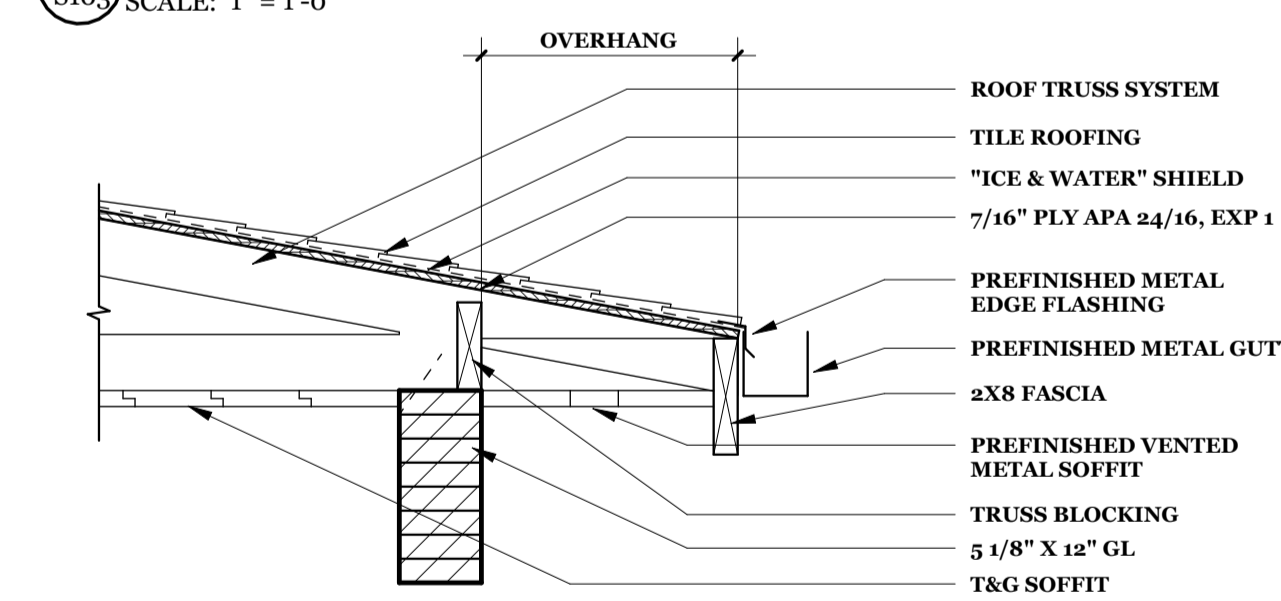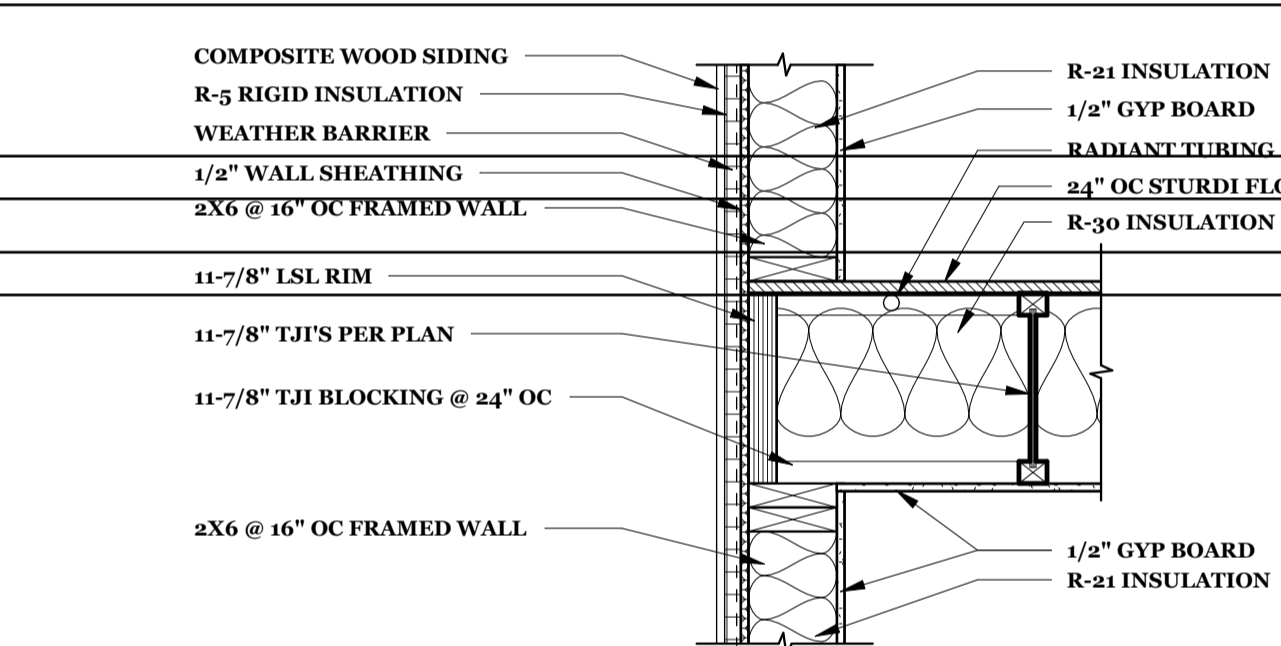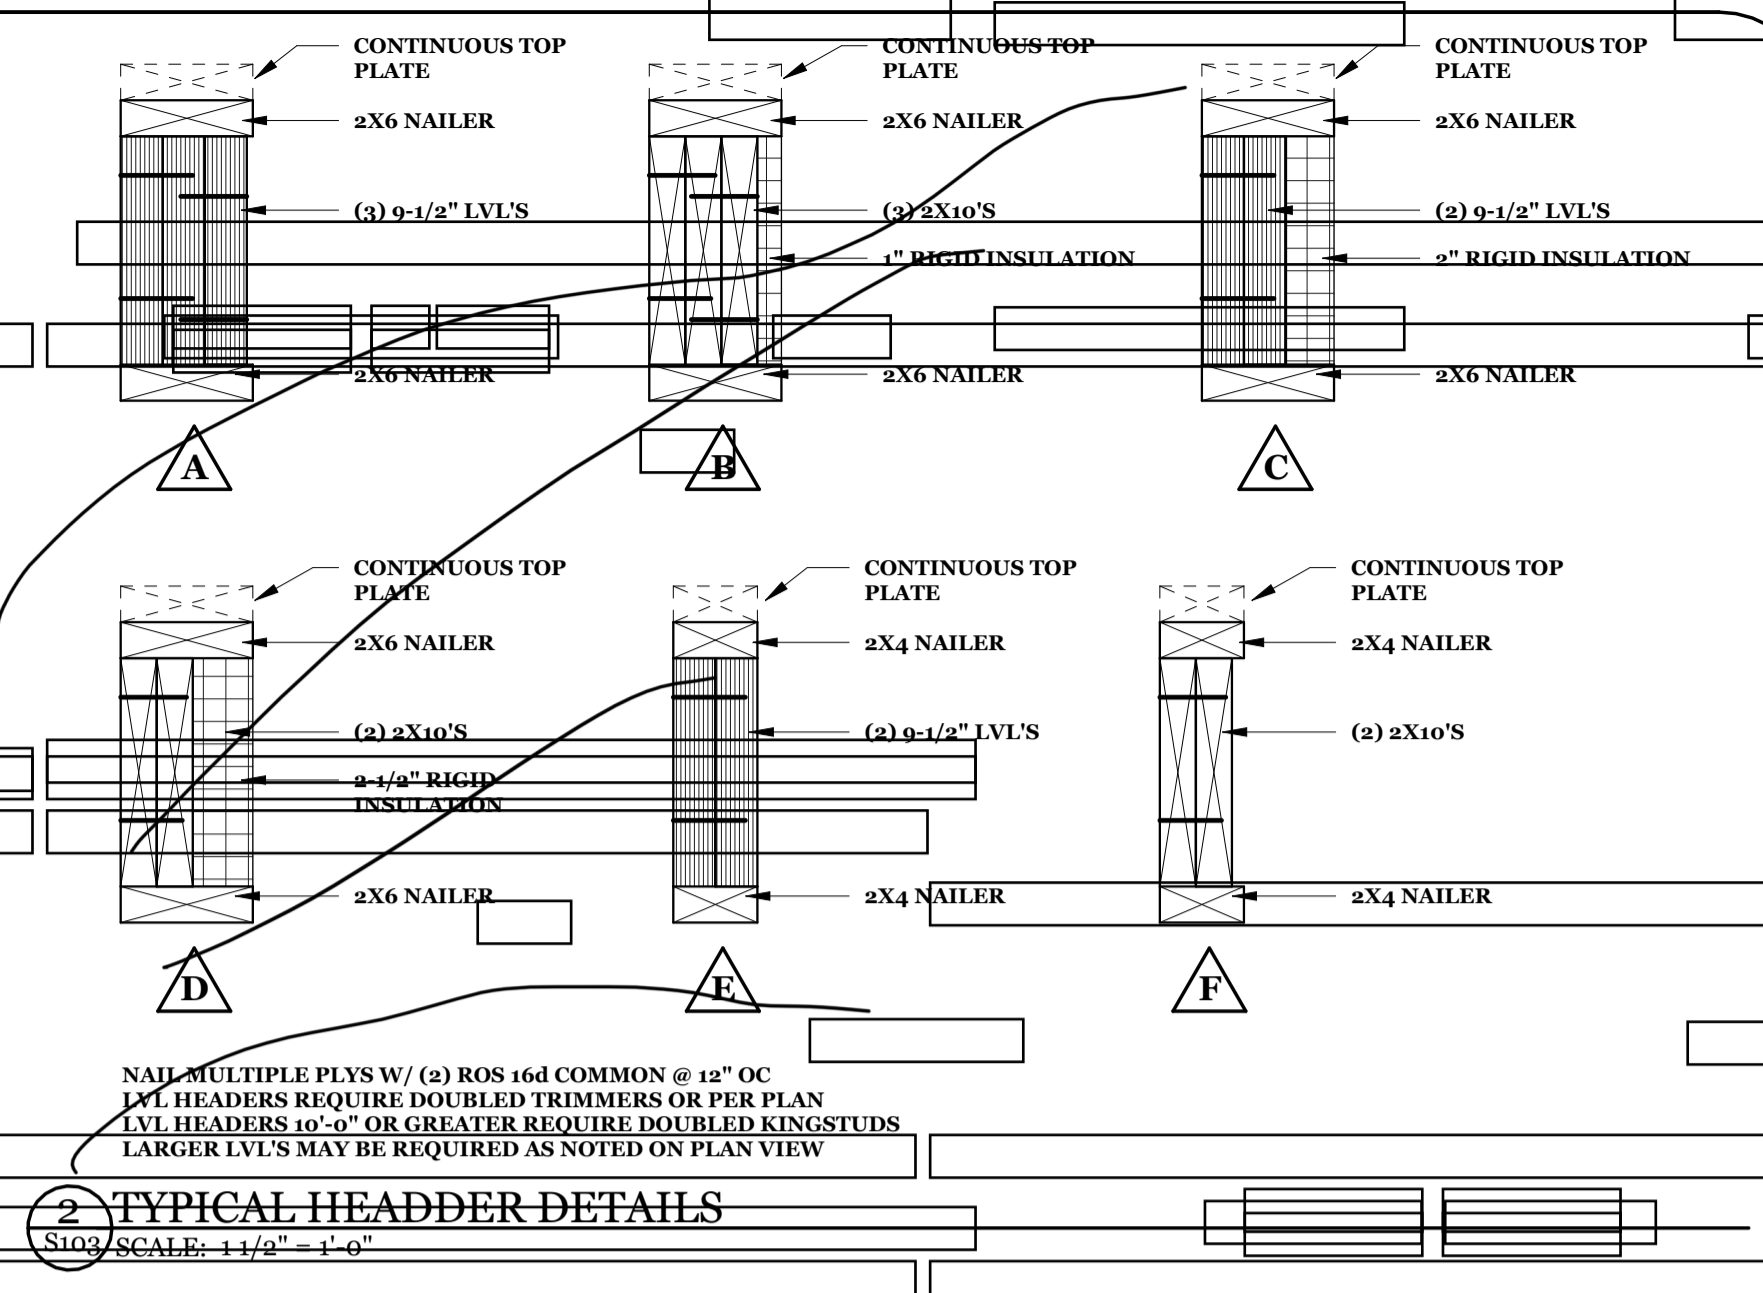

GLOCK RESIDENCE
30 GENEVA LN
SHERIDAN, WY 82801
OWNER/CONTRACTOR 480.239.6512


SHERIDAN WYOMING
BRIDGER ENGINEERING AND DESIGN
BE
Professional Engineer
KYLE A. BRIDGER
17110
Date 2022-11-16
WYOMING
"STRUCTURE ONLY"

UPPER LEVEL AND LOWER ROOF FRAMING PLAN


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Sheet Number
S103
SHEET 13 OF 14


1 UPPER ROOF FRAMING PLAN
S104 SCALE: 3/16" = 1'-0"

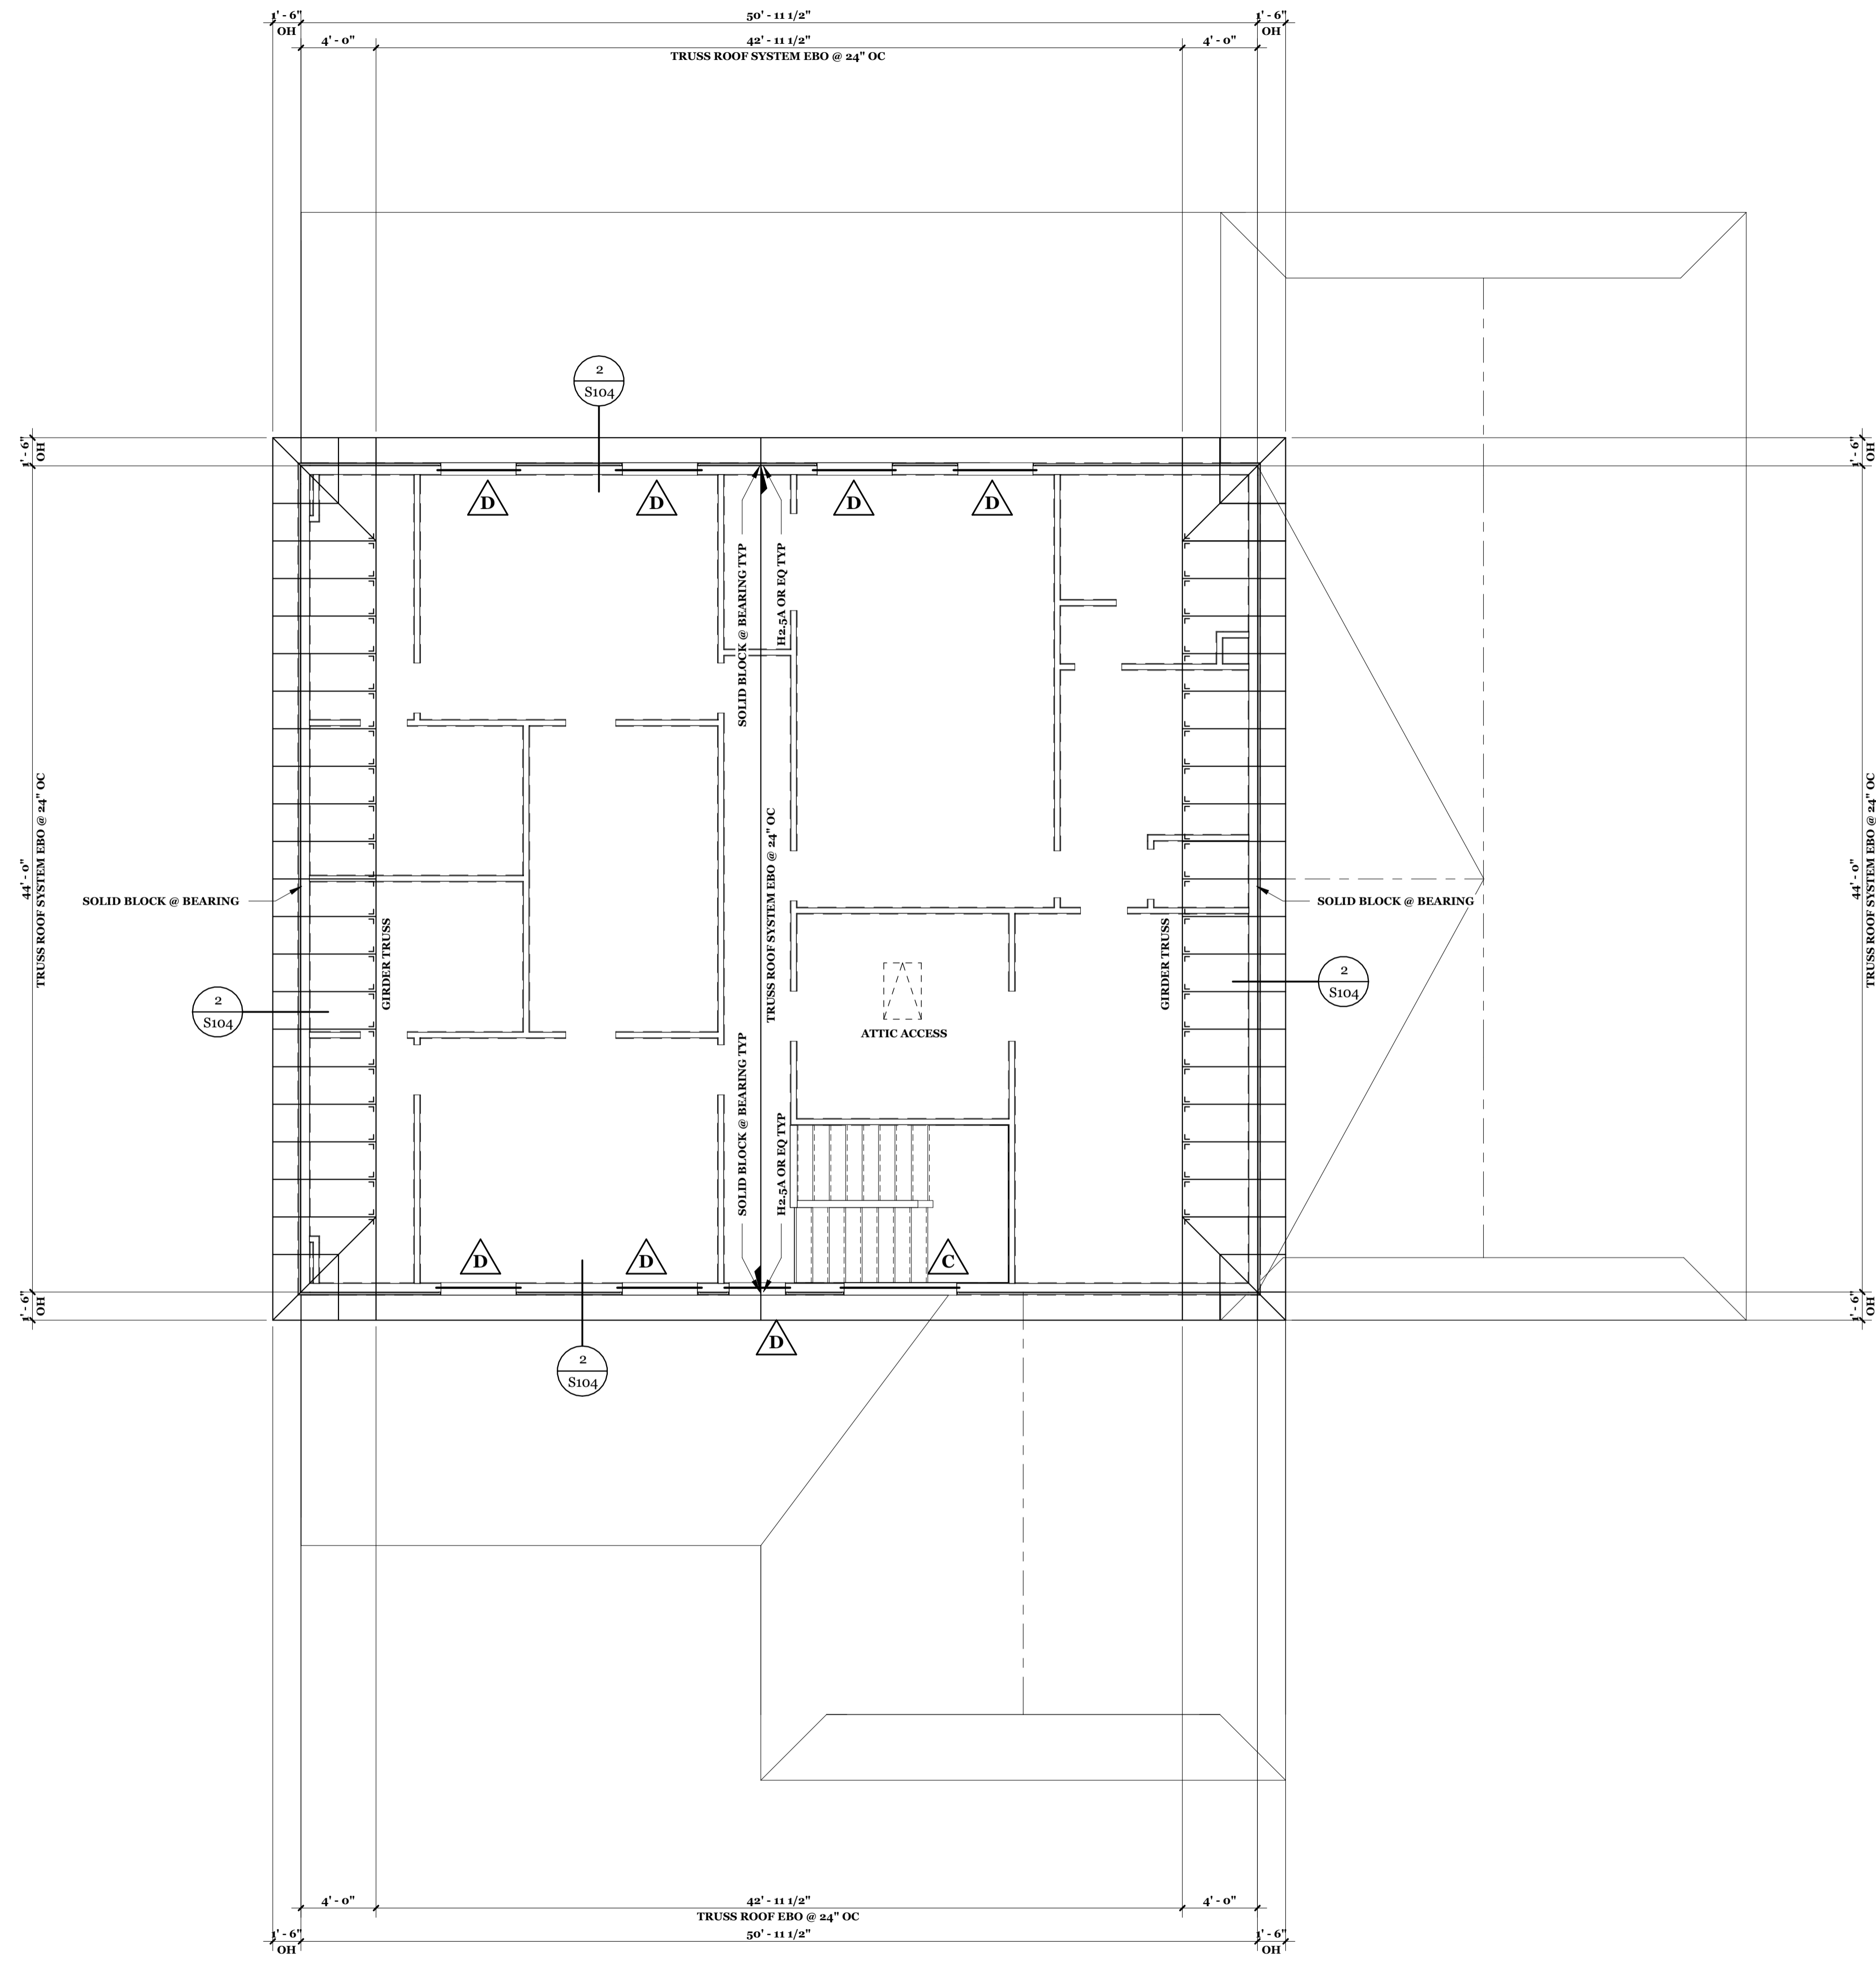


SHEATH ROOFS W/ 7/16" PLY APA 24/16 EXP 1

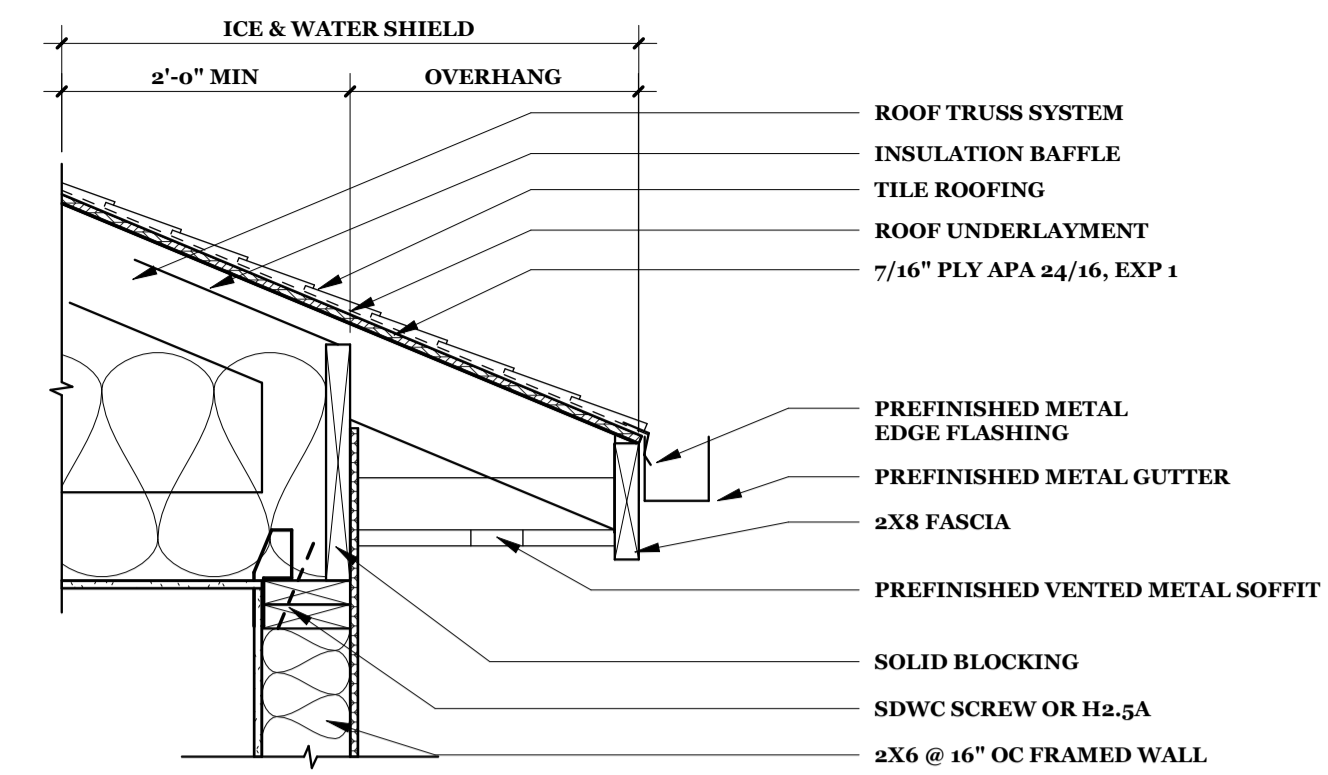

2 ROOF EDGE DETAIL
S104 SCALE: 1" = 1'-0"

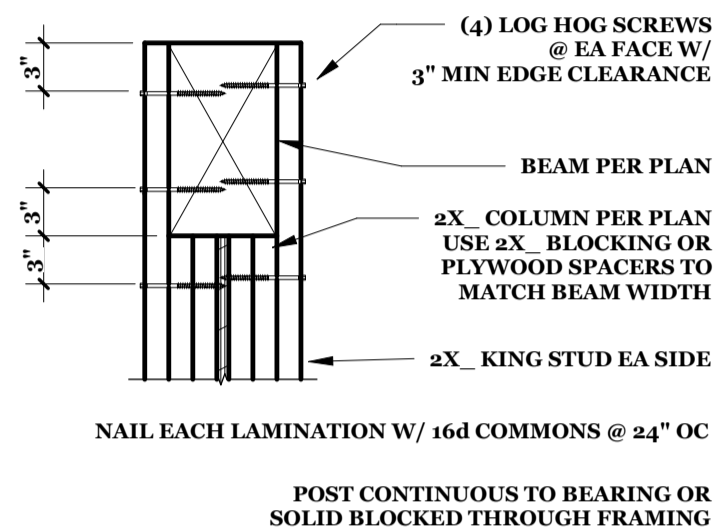

3 BUILT-UP COLUMN
S104 SCALE: 1" = 1'-0"

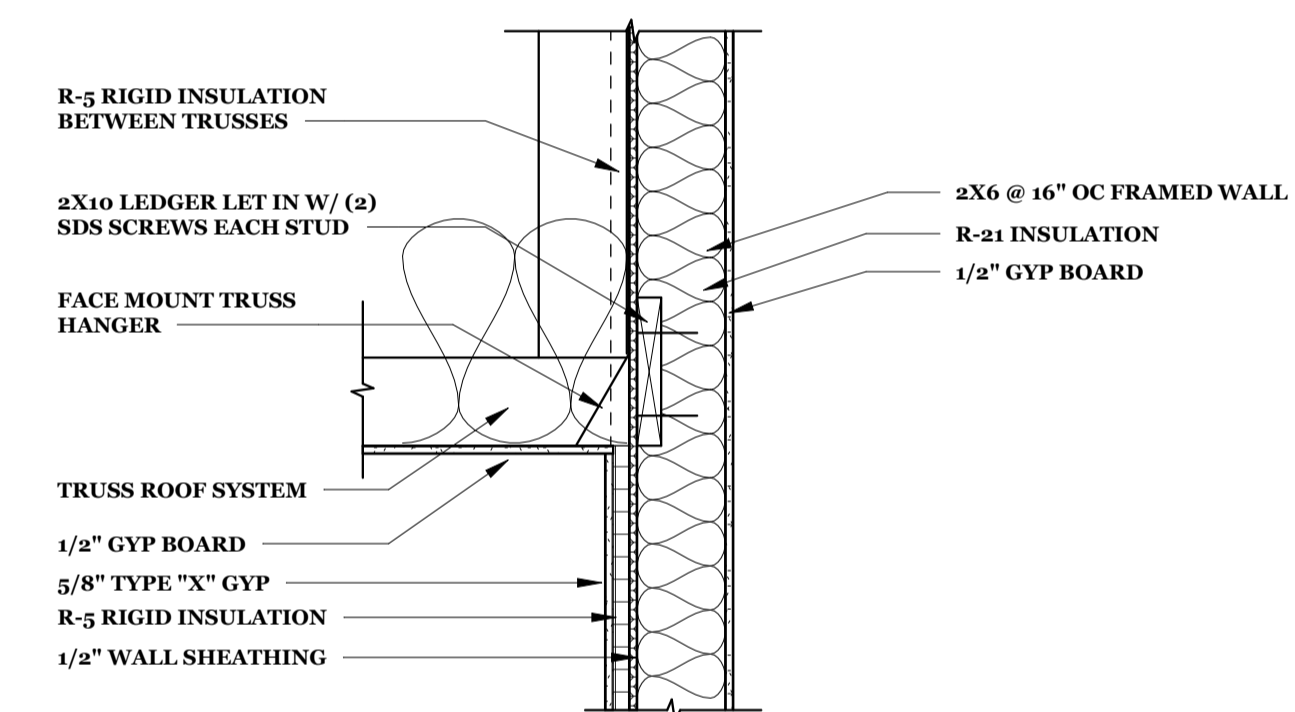

4 ROOF FRAMING DETAIL A
S104 SCALE: 1" = 1'-0"

SHERIDAN
WYOMING
307-752-9146

BRIDGER
ENGINEERING
AND DESIGN

BE

Professional Engineer
WYLE A. BRIDGER
17110
Date 2022-11-16
WYOMING
"STRUCTURE ONLY"

UPPER ROOF FRAMING PLAN

GLOCK RESIDENCE
30 GENEVA LN
SHERIDAN, WY 82801
OWNER/CONTRACTOR 480.239.6512

Job # 2022-22
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S104
SHEET 14 OF 14